



"CENTERLINE PROFILE OF WISPER LANE"

HORIZONTAL SCALE - 1"=50'
VERTICAL SCALE - 1"-5'

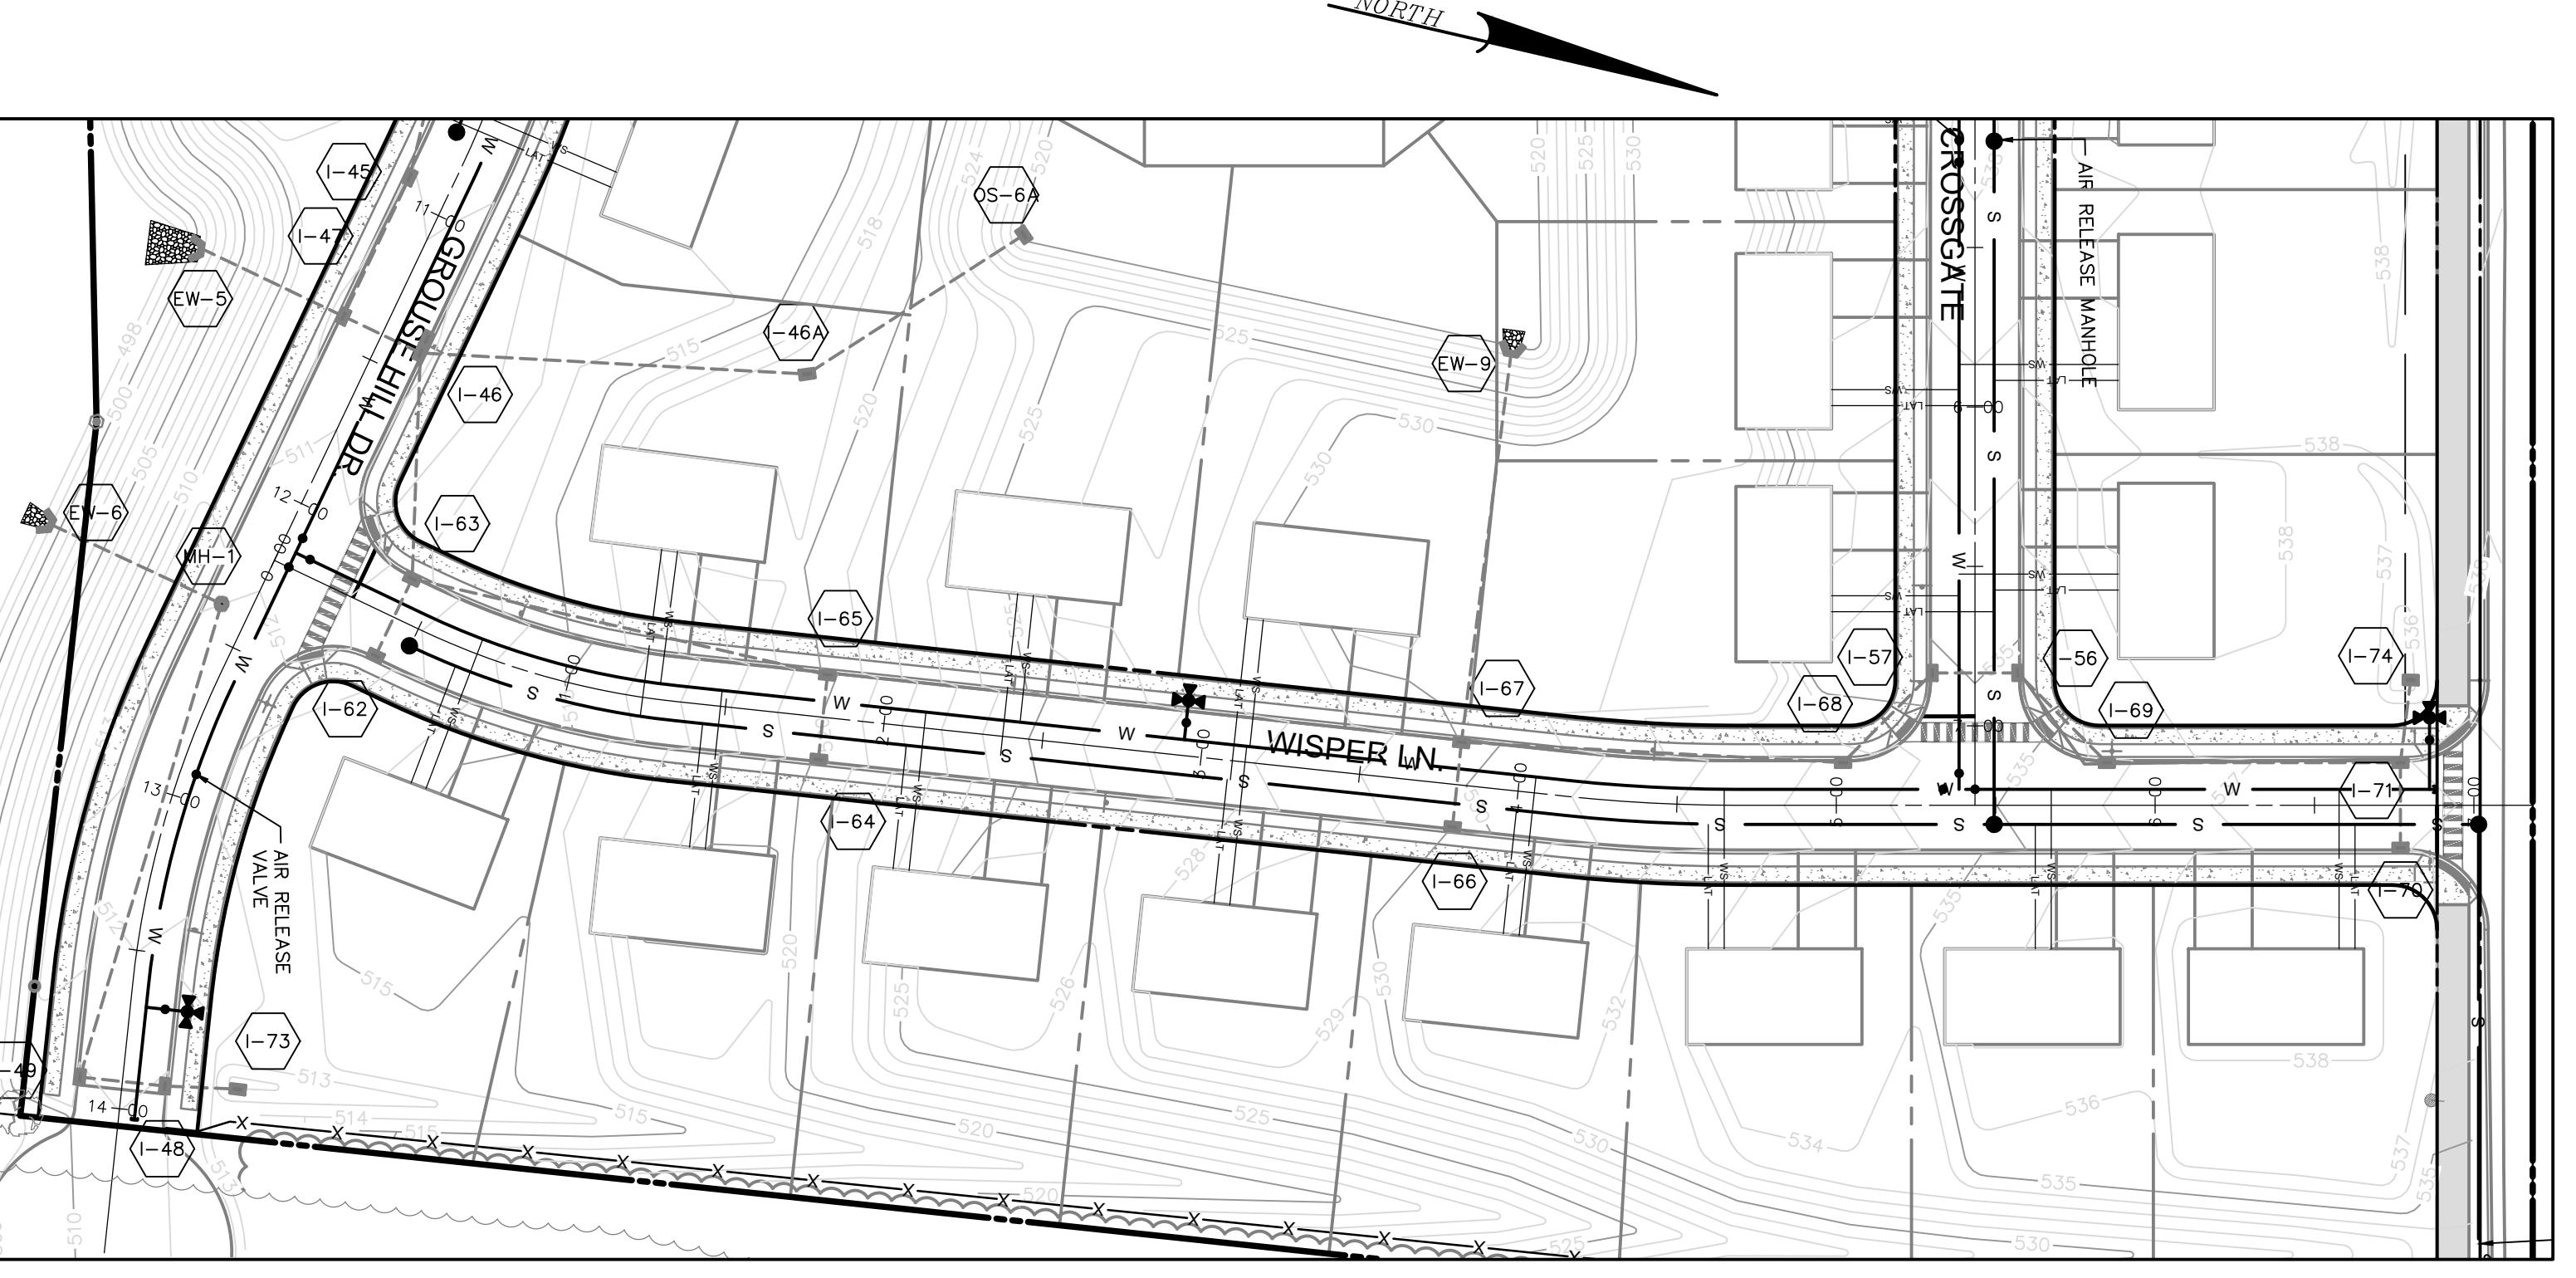


WISPER LANE PLAN VIEW

SCALE -

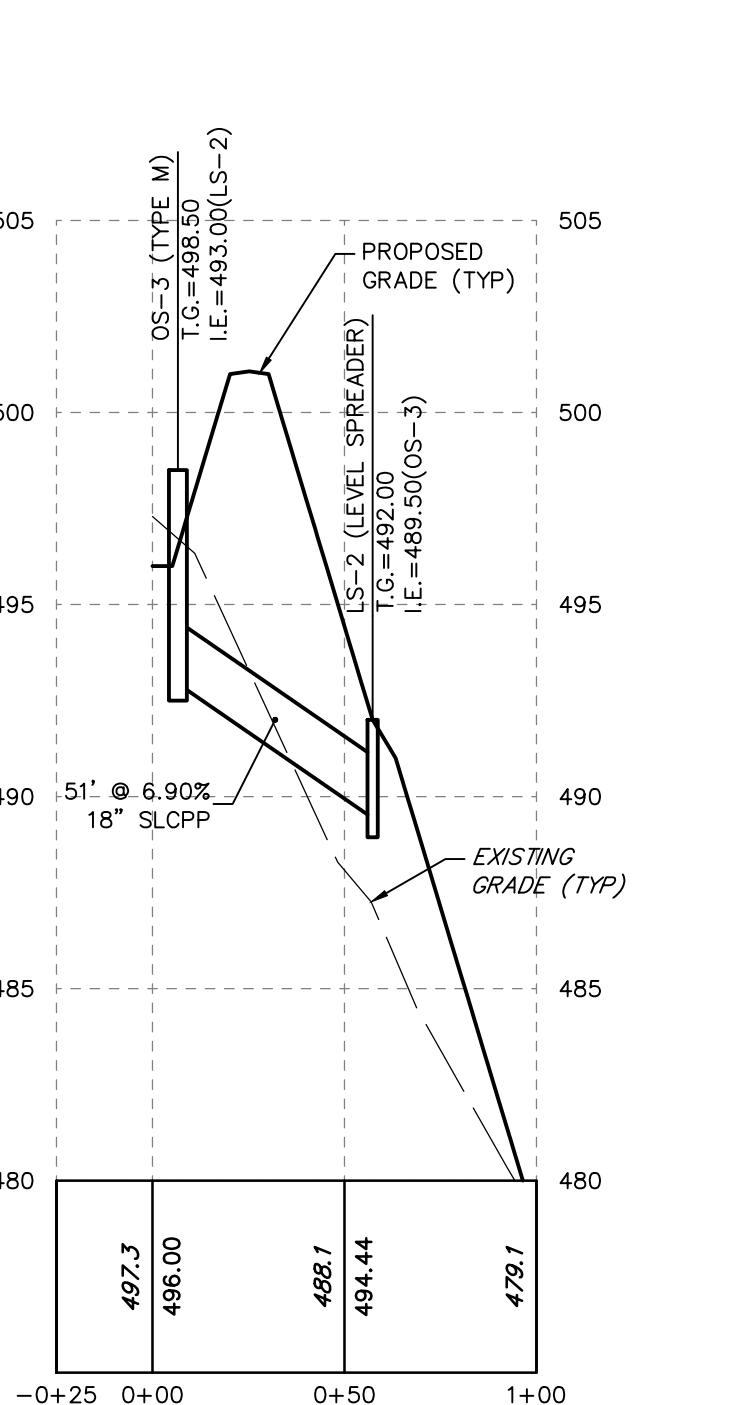

OS-3 TO LS-2


HORIZONTAL SCALE - 1"=50'
VERTICAL SCALE - 1"=5'

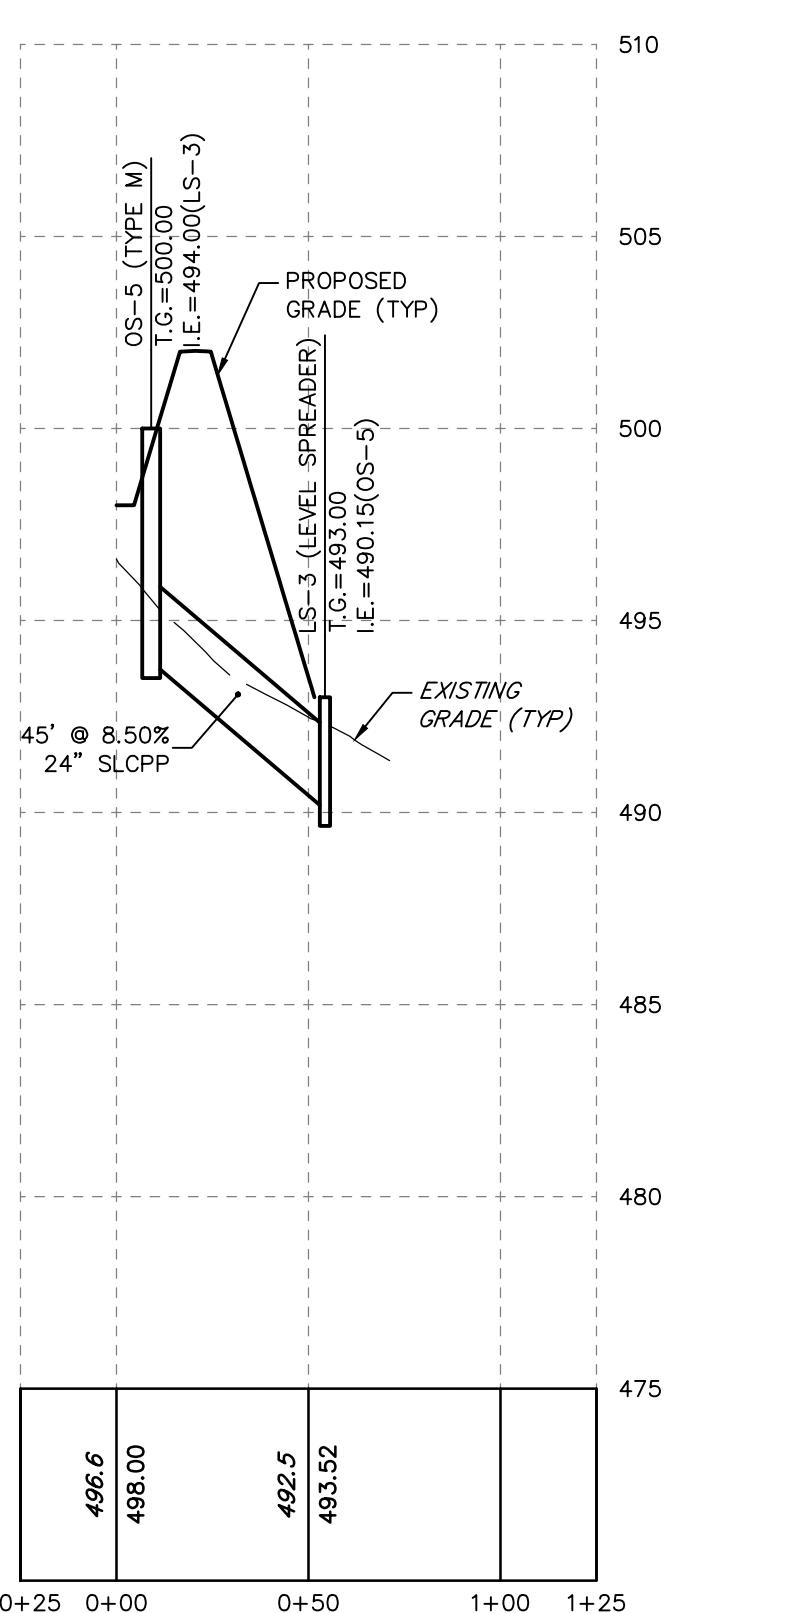

S-5 TO LS-3


HORIZONTAL SCALE - 1"=50'
VERTICAL SCALE - 1"=5'

NOT FOR CONSTRUCTION / NOT FOR BIDDING

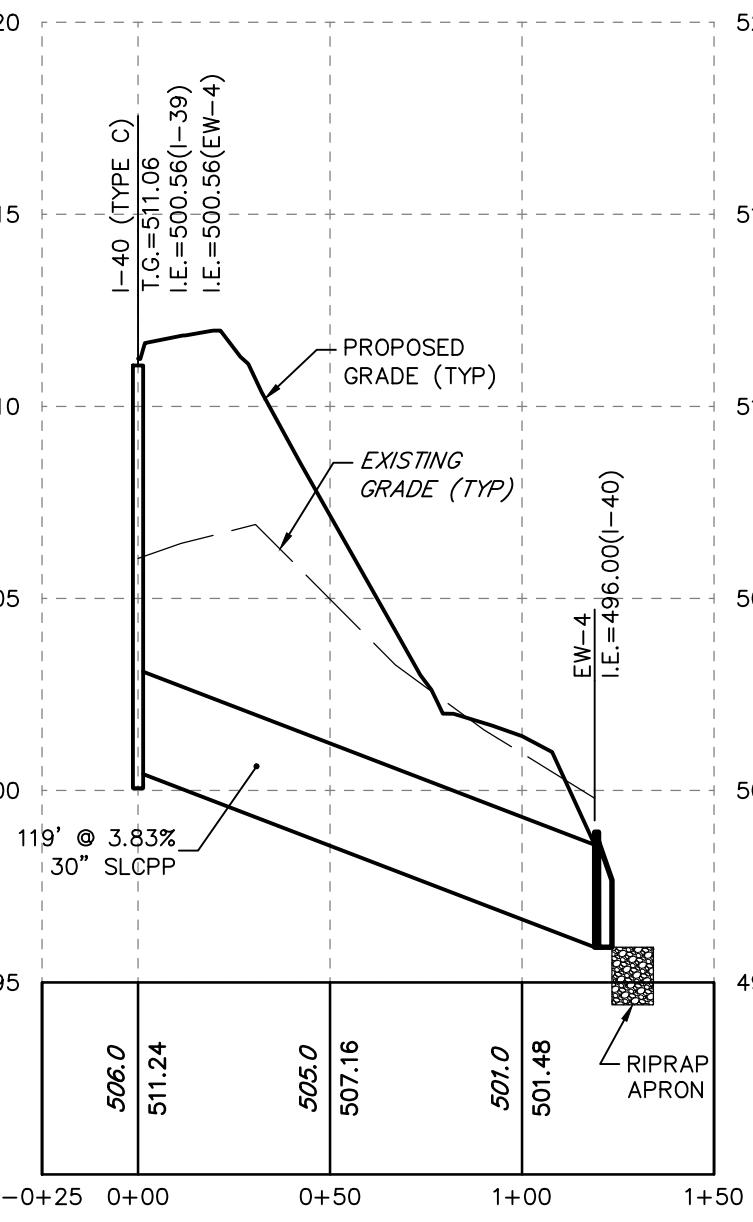


I-40 TO EW-4

HORIZONTAL SCALE - 1"=50'
VERTICAL SCALE - 1"=5'

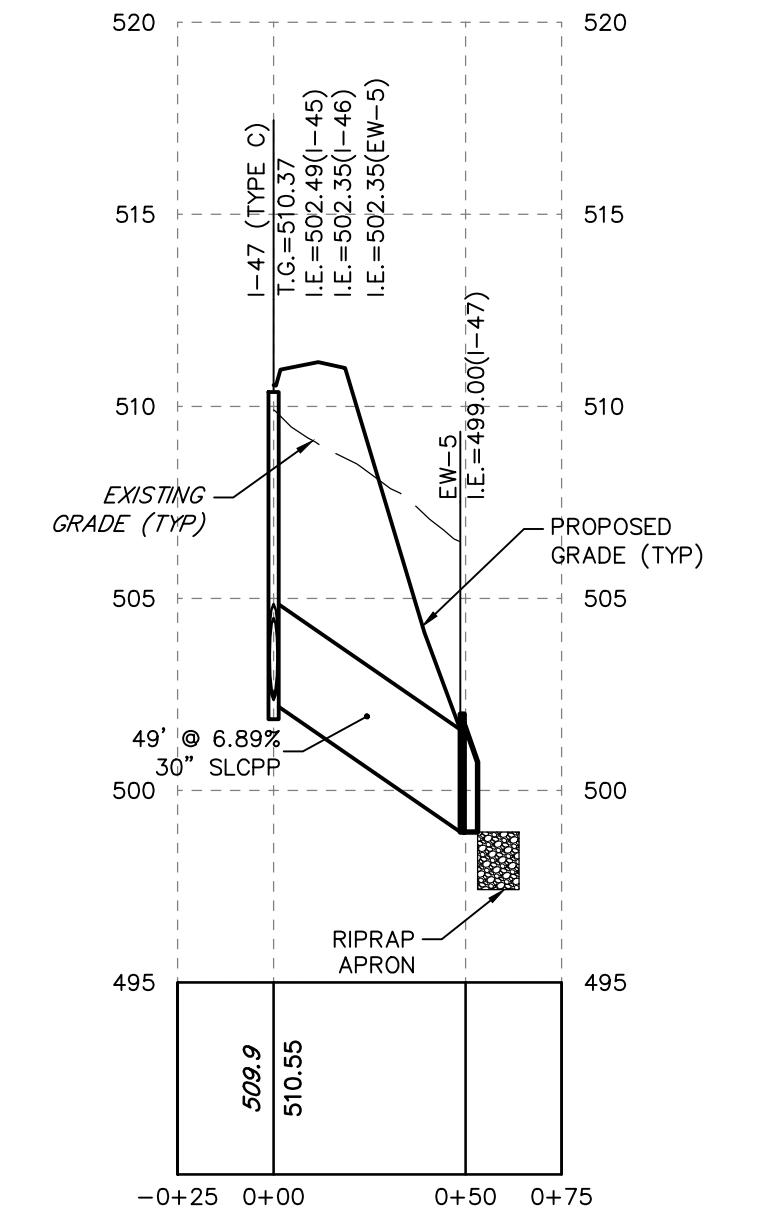


I-47 TO EW-5

HORIZONTAL SCALE - 1"=50'
VERTICAL SCALE - 1"=5'

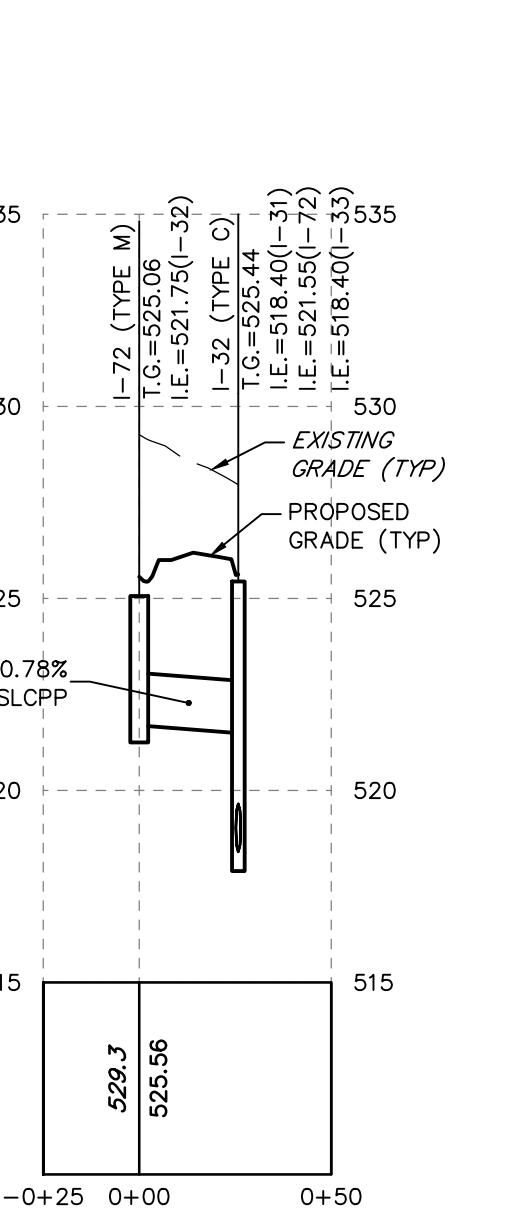


-72 TO I-32

HORIZONTAL SCALE - 1"=50'
VERTICAL SCALE - 1"=5'

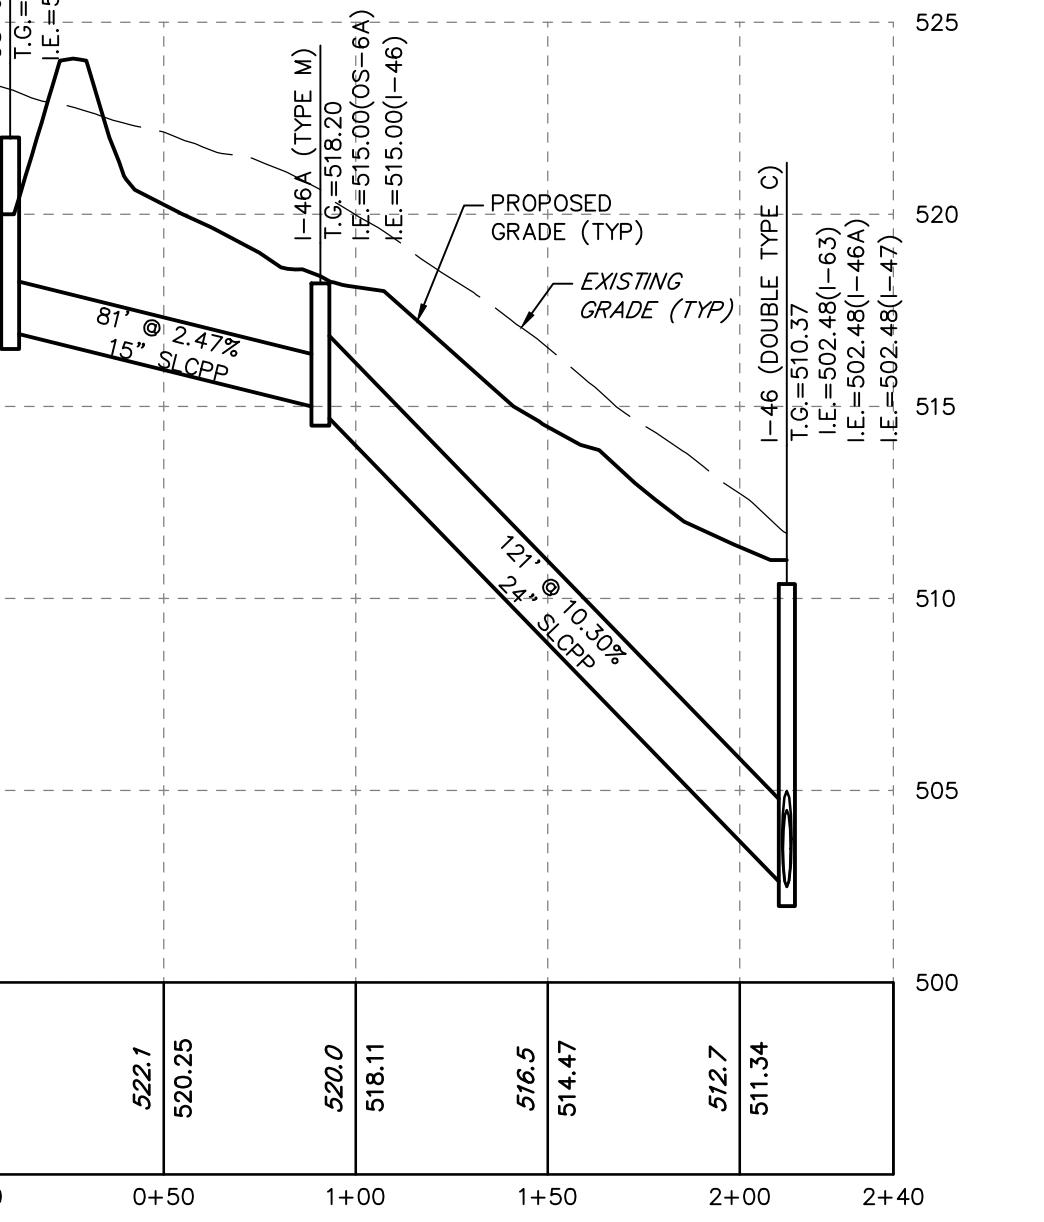


-6A TO I-46

HORIZONTAL SCALE - 1"=50'
VERTICAL SCALE - 1"=5'

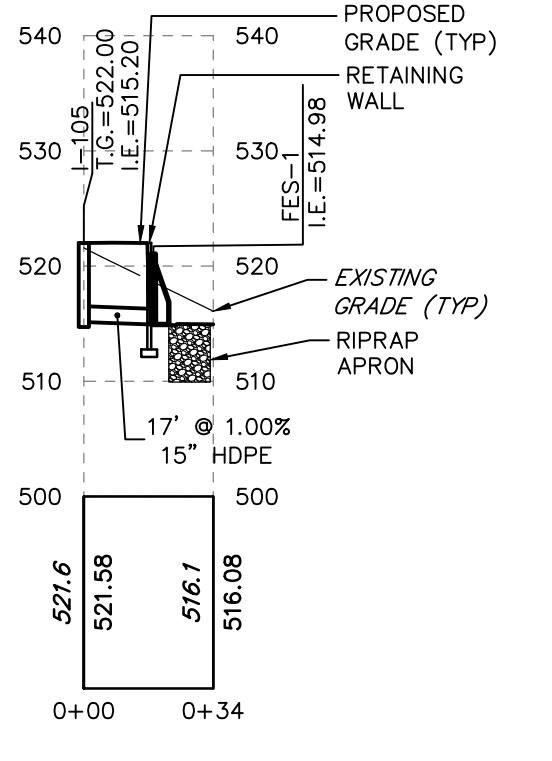


CENTERLINE PROFILE OF I-105 TO FES-1"

HORIZONTAL SCALE - 1"=50'
VERTICAL SCALE - 1"=17'

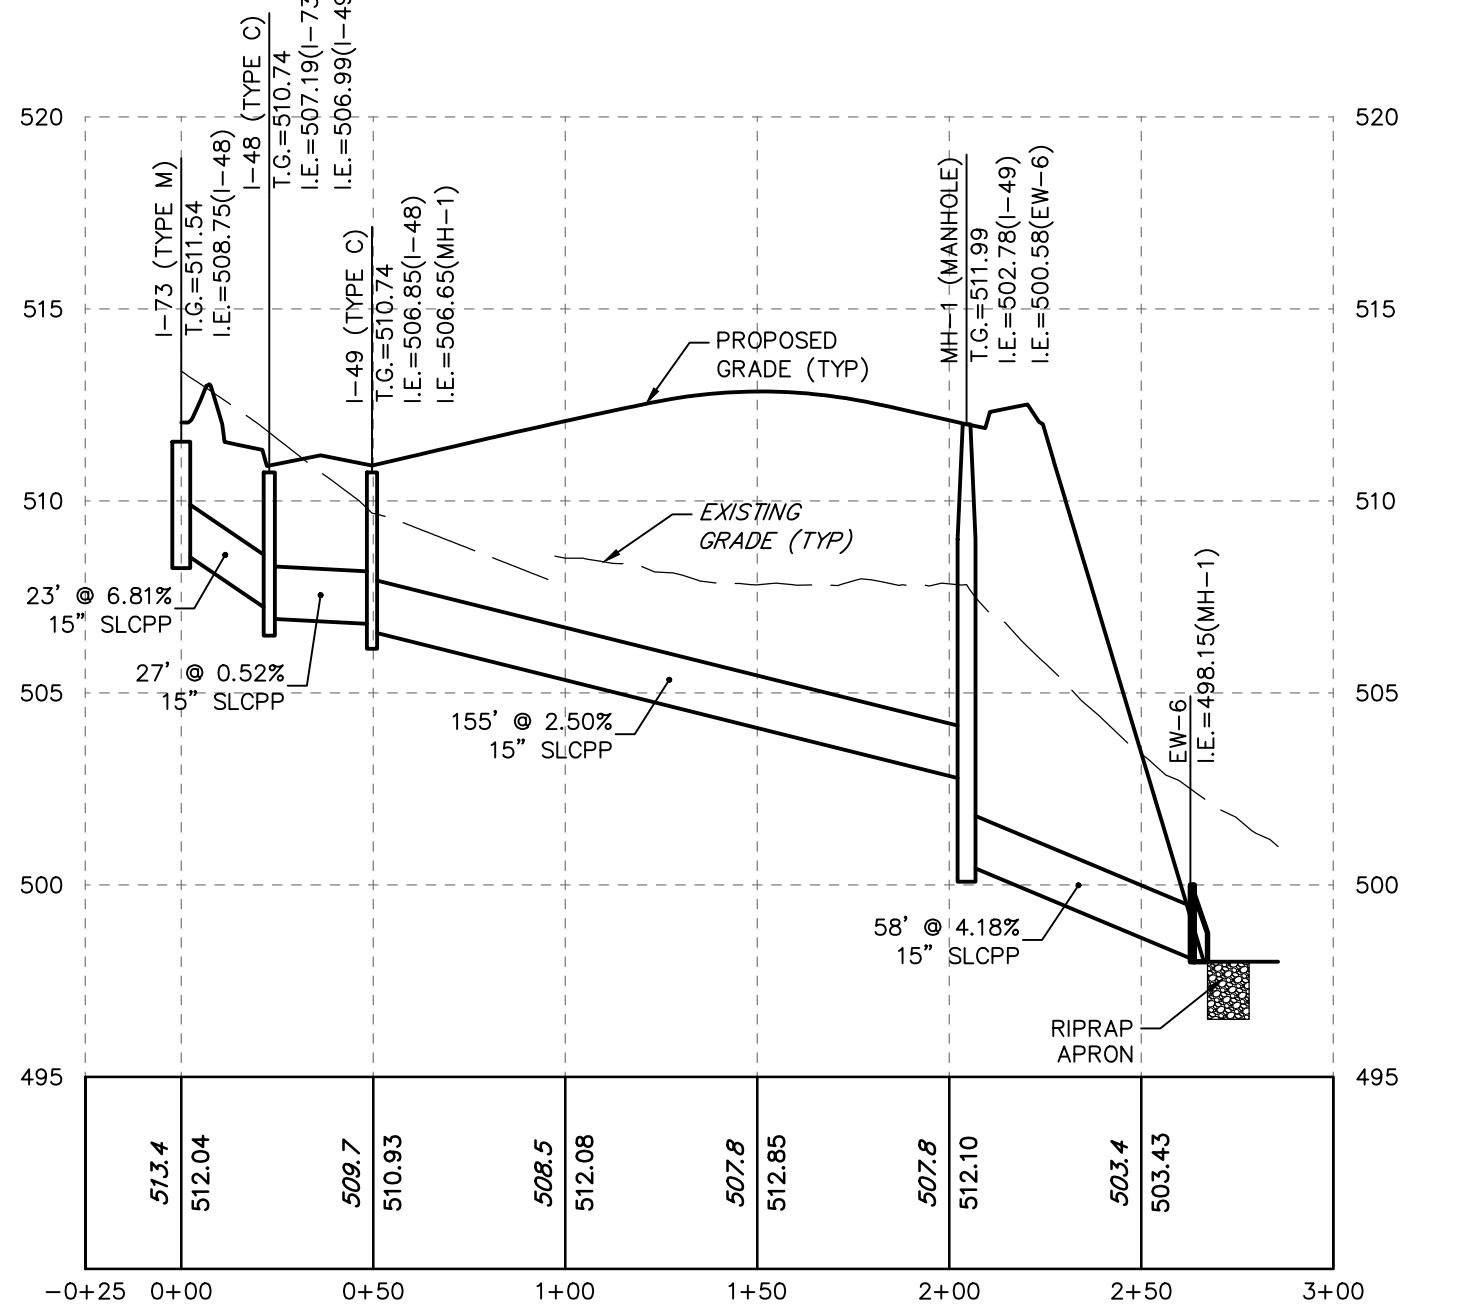


I-73 TO EW-6

HORIZONTAL SCALE - 1"=50'
VERTICAL SCALE - 1"=5'

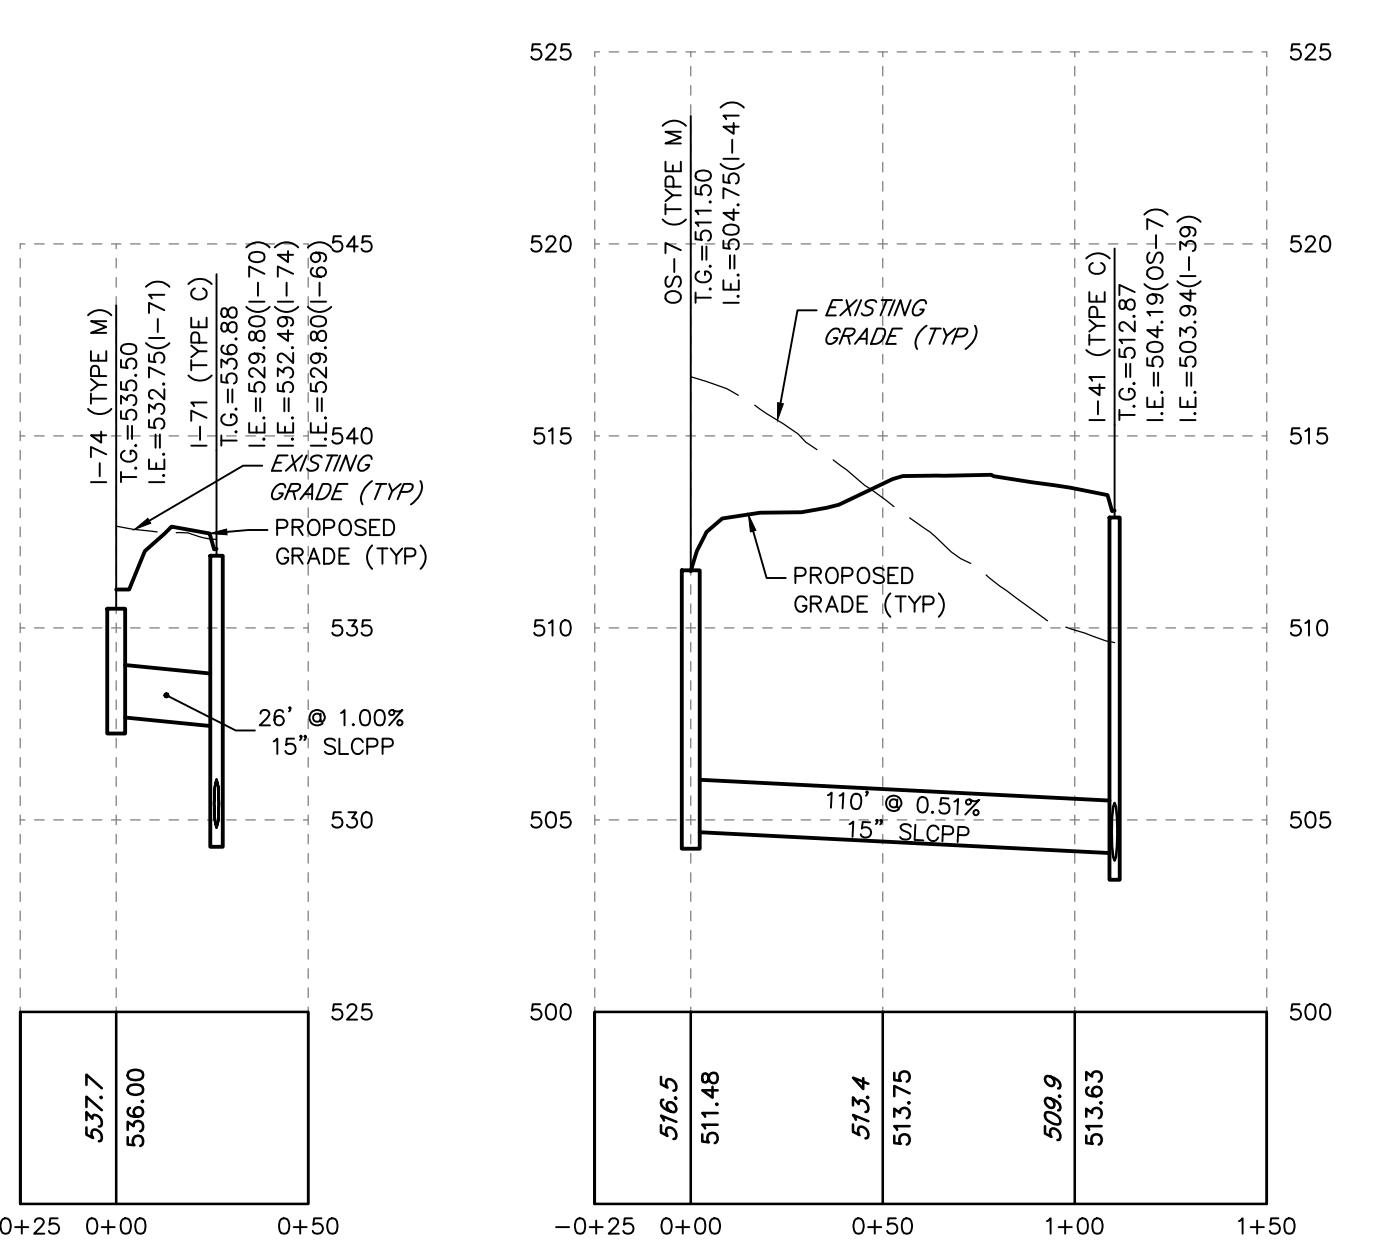


I-74 TO I-71

HORIZONTAL SCALE - 1"=50'
VERTICAL SCALE - 1"=5'

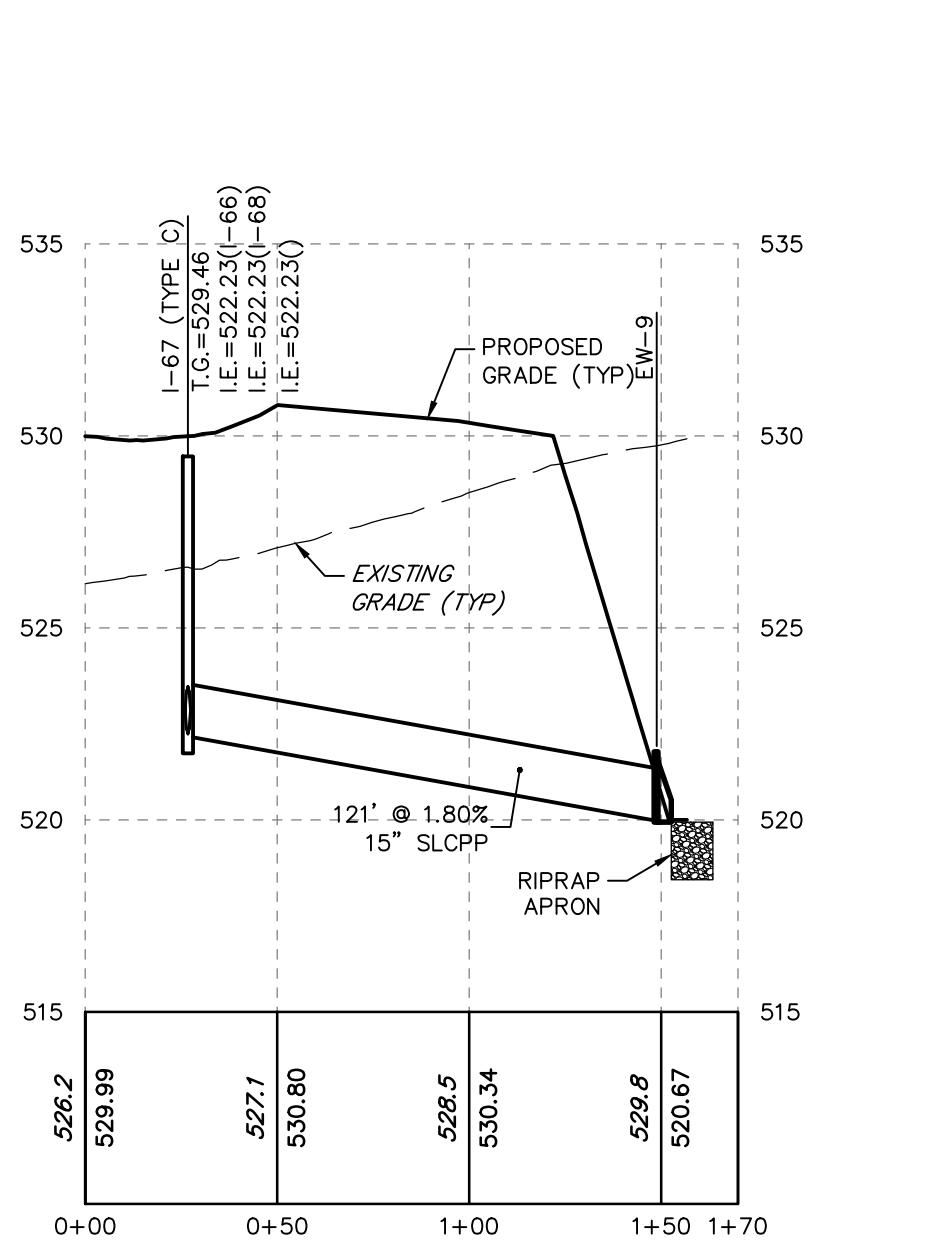

I-67 TO EW-9

HORIZONTAL SCALE - 1"=50'
VERTICAL SCALE - 1"=5'

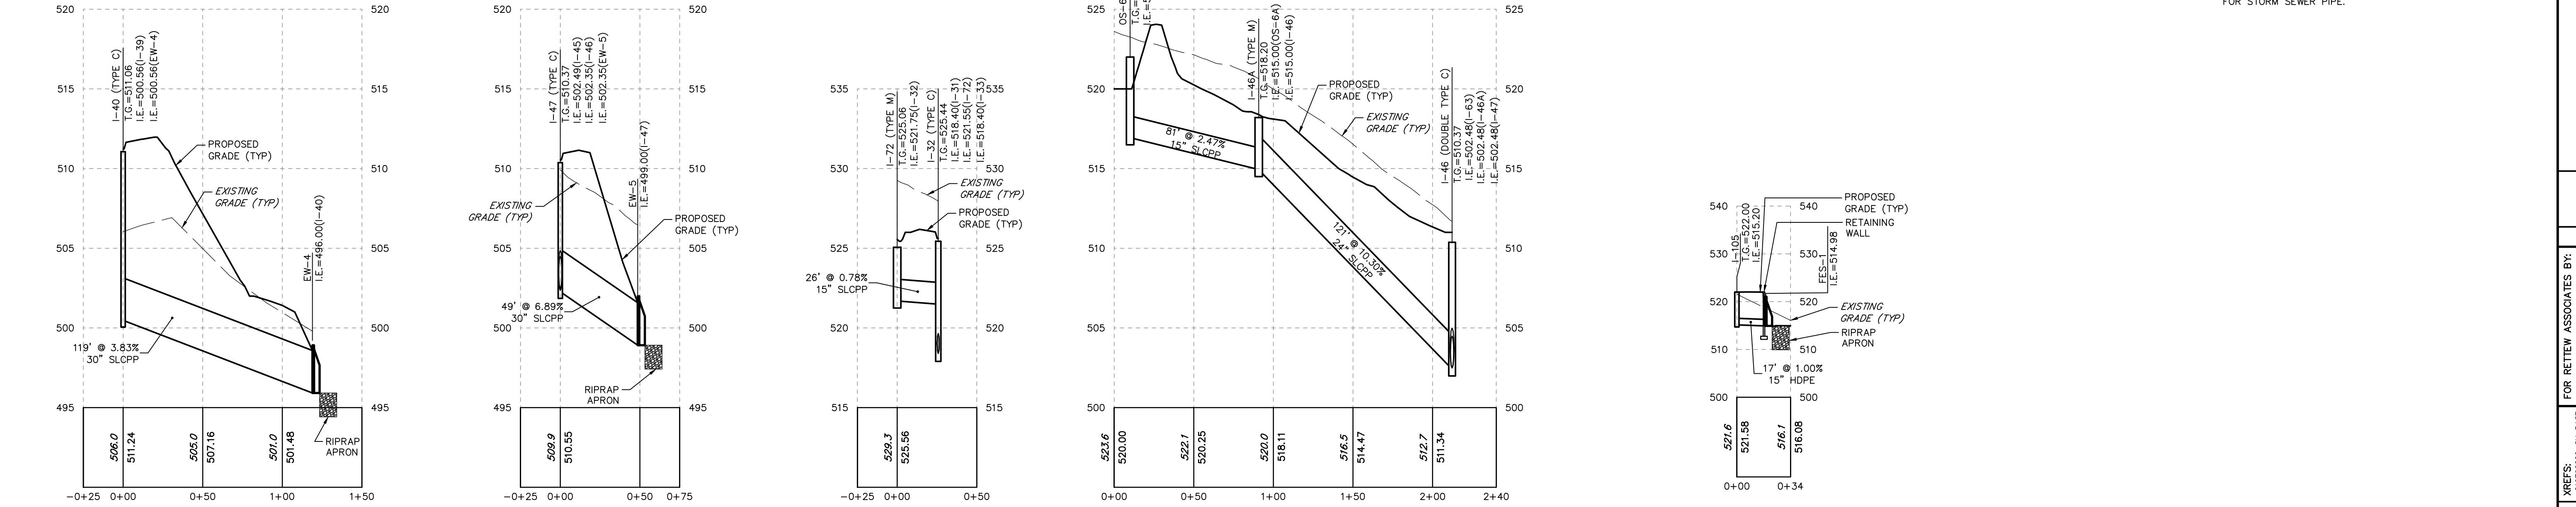

OTES:

- INLETS AND MANHOLES GREATER THAN FIVE FEET IN DEPTH
SHALL BE EQUIPPED WITH LADDER RUNGS.
RETAINING WALL DESIGNER SHALL PROVIDE SLEEVE DETAIL
FOR STORM SEWER PIPE.


KGH DEVELOPMENT
120 NORTH POINT
LANCASTER, PA
(717) 560-9000

RUBBLE SM
ID DEVELOPMENT,
ND LOT ADD-ON PLAN
RETEW Associates Inc

**RAFFENSPER
MOUNT JOY TOWNSHIP**


FINAL LAND
SUBDIVISION, A

E: 4/12/24

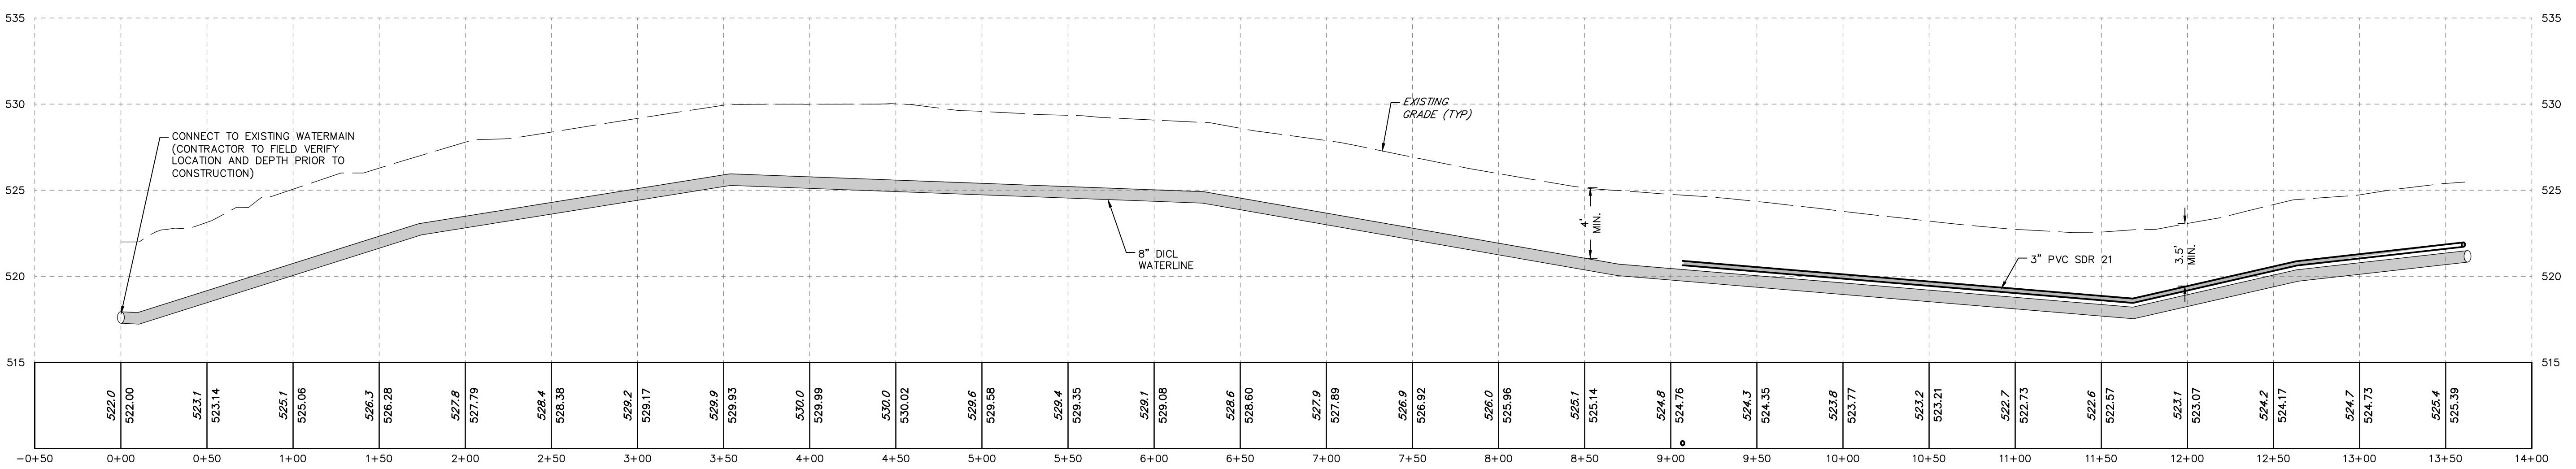


SHEAFFER ROAD WATER AND SANITARY

HORIZONTAL SCALE - 1"=50'
VERTICAL SCALE - 1"=5'

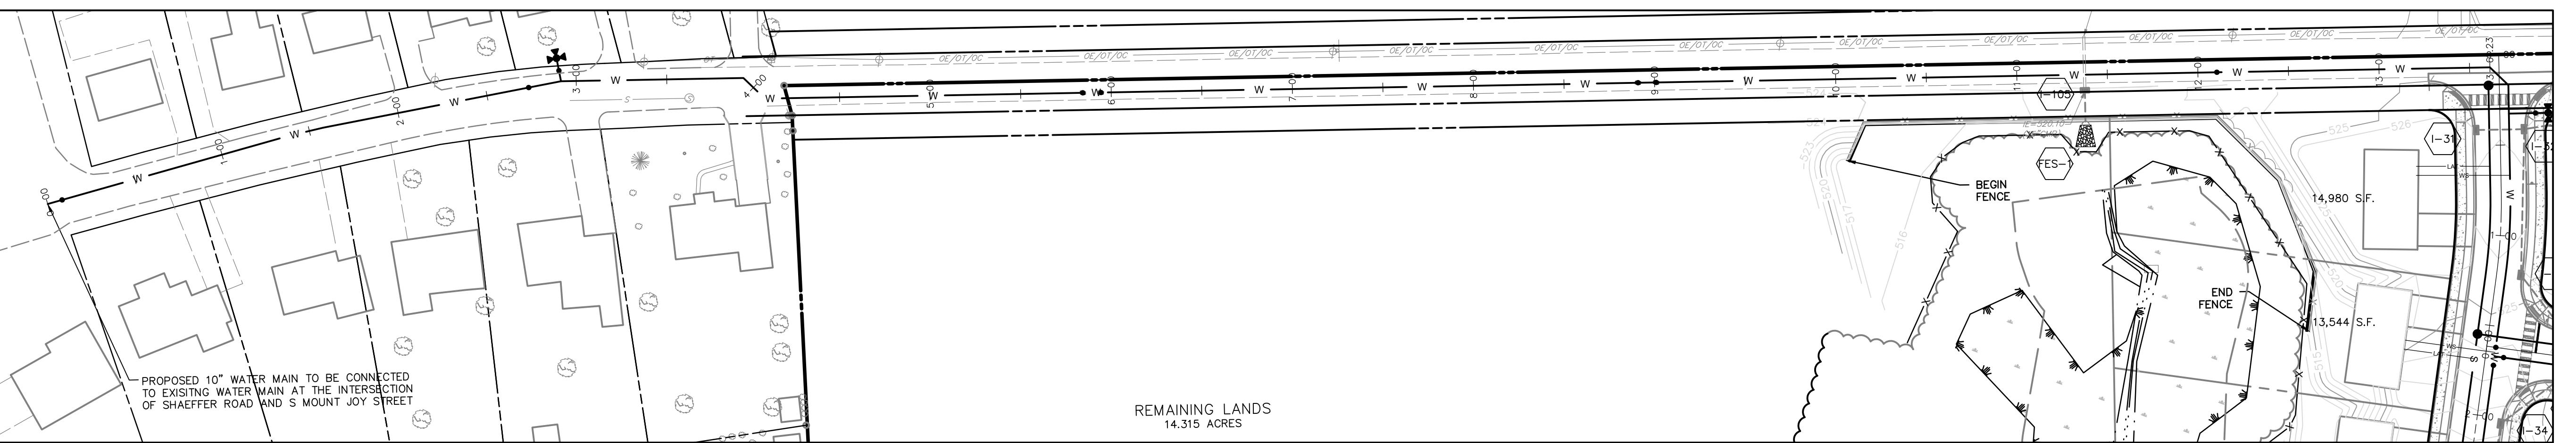


SHEAFFER ROAD WATER AND SANITARY PLAN VIEW

SCALE = 1"=50'

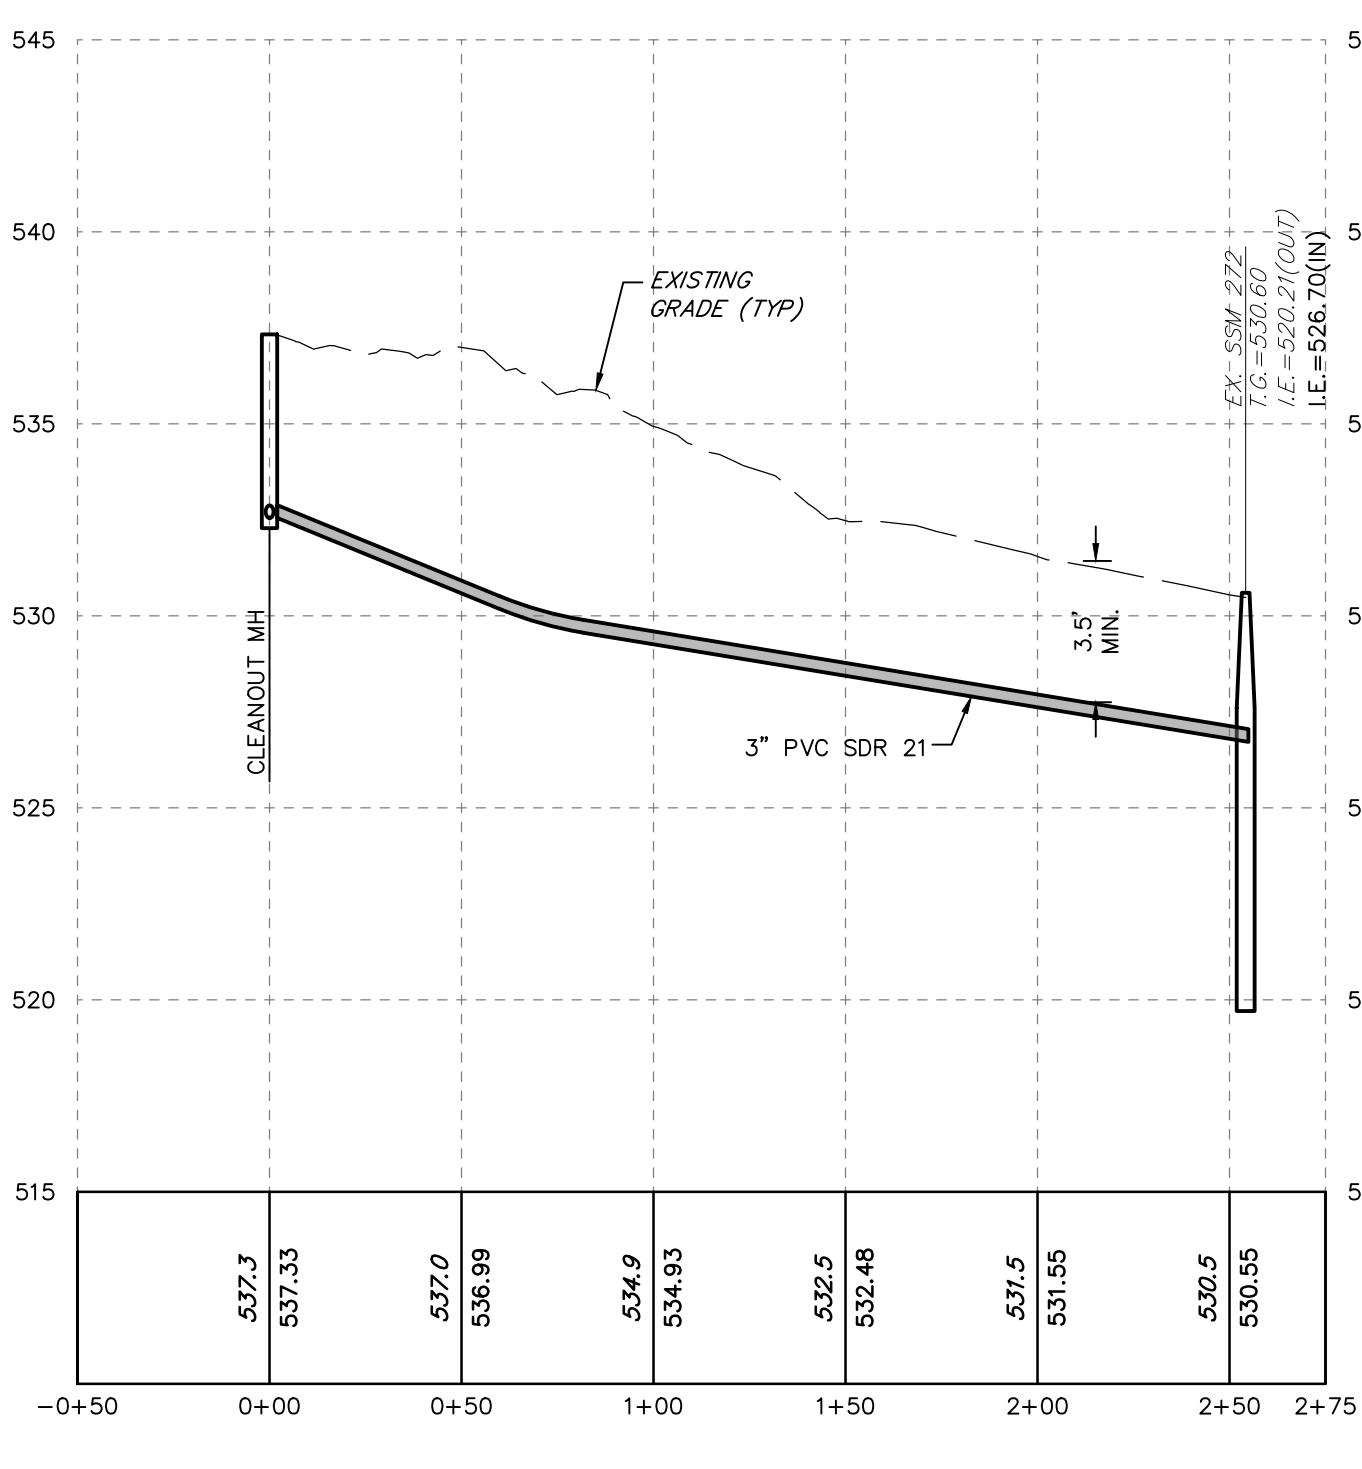

SANITARY SEWER CONNECTION

HORIZONTAL SCALE - 1"=50'
VERTICAL SCALE - 1"=5'

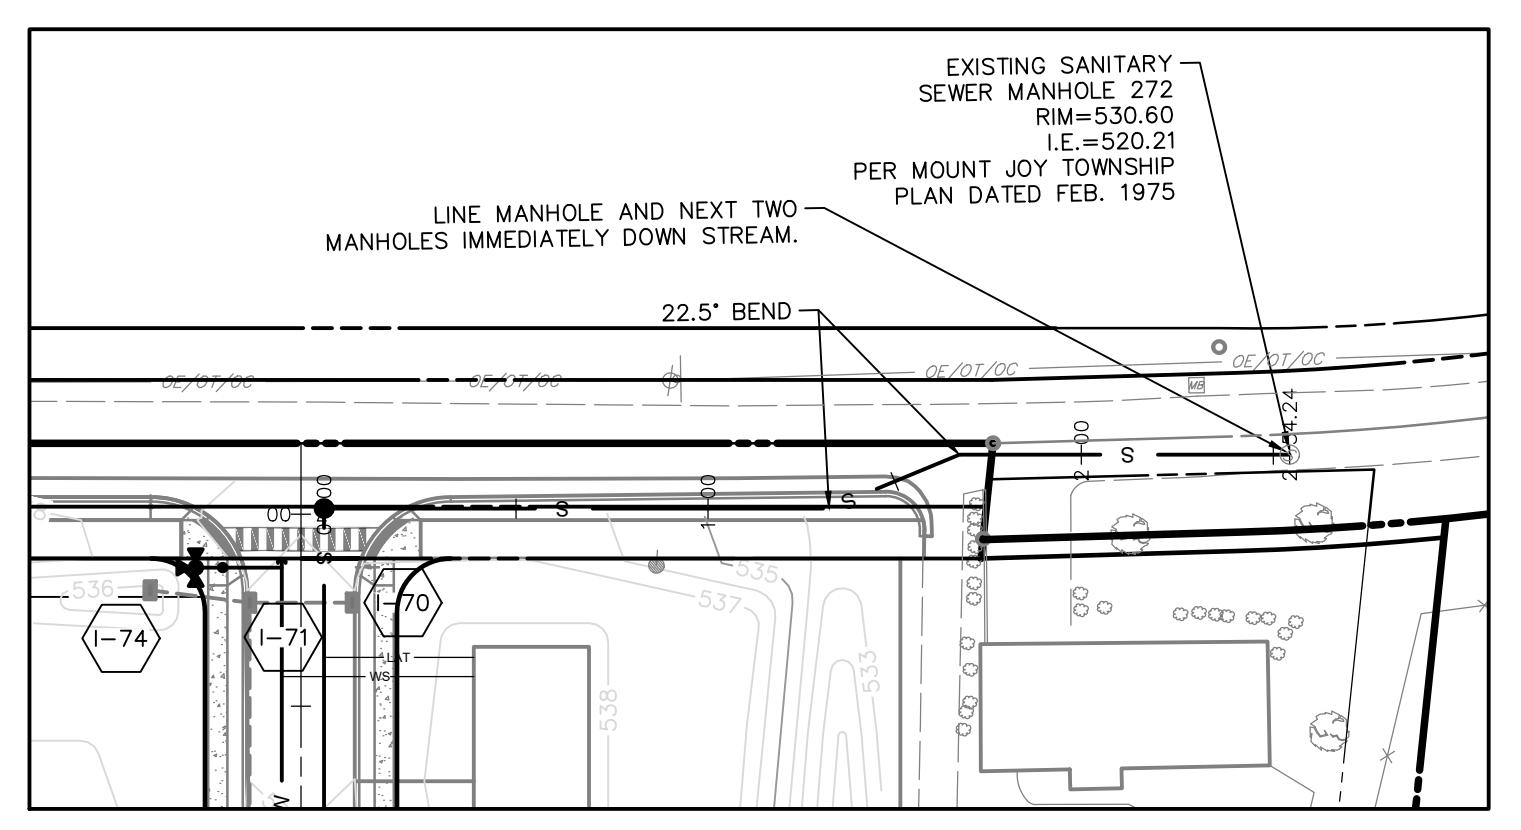

SANITARY SEWER CONNECTION PLAN VIEW

SCALE - 1"=50

DEPTH	RAFFENSPERGER – PHASE 1		MOUNT JOY TOWNSHIP		LANCASTER COUNTY, PA		Engineers • Planners • Surveyors • Landscape Architects Environmental Consultants	
	DATE:	4/12/24	SHEET NO.	24 OF 33	DWG NO	019792000	C:\CADD\System\Software\Autodesk\TempACAD\TempDWG\AcPublish_71540\019792000-Final Plan-Phase 1.DWG	
PROFILES		FINAL LAND DEVELOPMENT, SUBDIVISION, AND LOT ADD-ON PLAN		RAFFENSPERGER – PHASE 1		DRAWING REFERENCE: C:\CADD\System\Software\Autodesk\TempACAD\TempDWG\AcPublish_71540\019792000-Final Plan-Phase 1.DWG		
RETTEW		KGH DEVELOPMENT 120 NORTH POINTE BLVD. LANCASTER, PA 17601 (717) 560-9095		MANAGER: KIM M. FASNACHT		XREFS: 019792000-SV-BASE 019792000-LD-BASE-PH2 019792000-LD-ESMT PHASED 019792000-LD-GRAD PHASED 019792000-LD-UTIL PHASED 019792000-SV-USGS PHASED 019792000-LD-DETL PHASED 019792000-SV-TOPO PHASED 019792000-LD-LAND KEY MAP PHASED 019792000-LD-SUBD PHASED 019792000-LD-PHASE BOUNDARY		
RETTEW		SUBDIVISION, AND LOT ADD-ON PLAN		DESIGN BY: JAR		CHKD BY: KMF		
RETTEW		FOR RAFFENSPERGER – PHASE 1		SURV. CHIEF: FIELDBOOK NO. DATA COLLECTOR		DRAWN BY: JAR		
RETTEW		MOUNT JOY TOWNSHIP		SCALE		1"=50' 100' 150'		
RETTEW		LANCASTER COUNTY, PA						
RETTEW		DATE:		NO. 9		DATE		
RETTEW		REVISION						
RETTEW		NORTH						

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10 of 10

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NOTES:


- INLETS AND MANHOLES GREATER THAN FIVE FEET IN DEPTH
SHALL BE EQUIPPED WITH LADDER RUNGS.

111

1

2

NOT FOR CONSTRUCTION / NOT FOR BIDDING

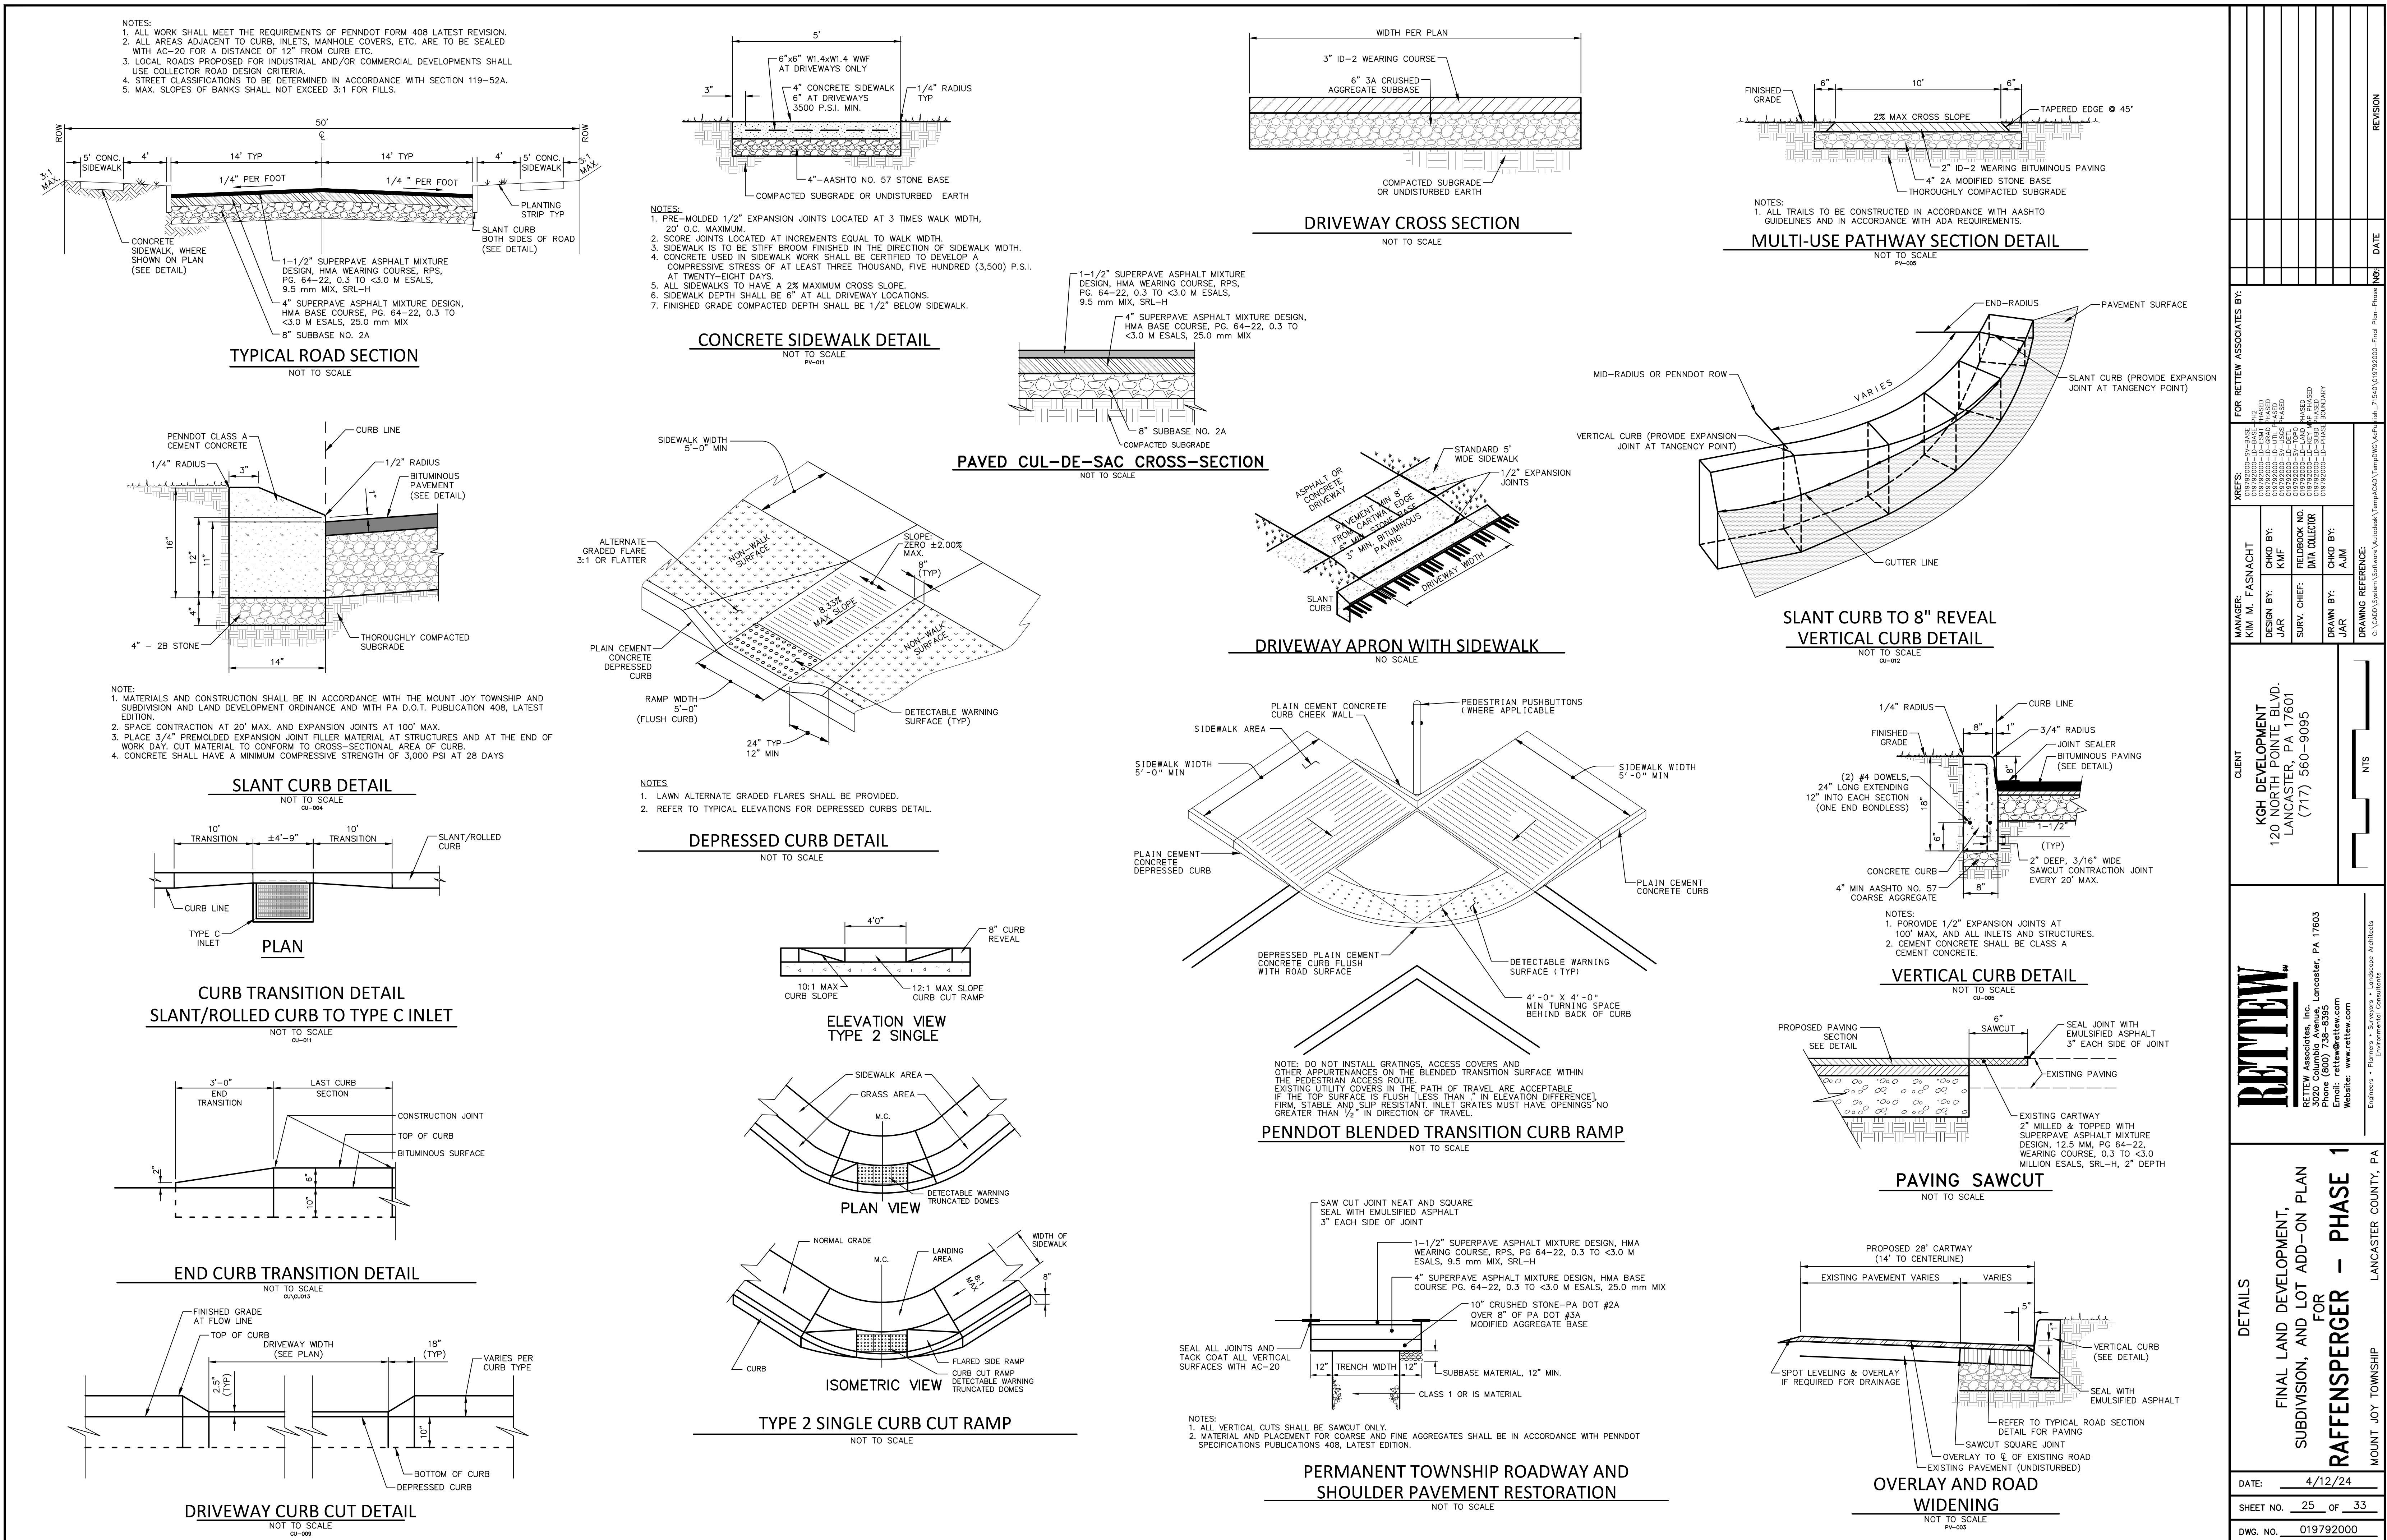

NOTES


1. SUBMIT TWO SETS OF DETAILED DESIGN CALCULATIONS AND FINAL RETAINING WALL PLANS FOR APPROVAL AT LEAST TWO WEEKS PRIOR TO THE BEGINNING OF WALL CONSTRUCTION. ALL CALCULATIONS AND DRAWINGS SHALL BE PREPARED AND SEALED BY A PROFESSIONAL ENGINEER REGISTERED IN PENNSYLVANIA.
2. UNLESS FURTHER GEOTECHNICAL EVALUATION IS CONDUCTED BY THE CONTRACTOR OR A QUALIFIED GEOTECHNICAL ENGINEER, USE THE FOLLOWING ASSUMED GEOTECHNICAL PARAMETERS IN THE PREPARATION OF THE FINAL WALL DESIGN:

UNIT WEIGHT (Y) (pcf)	INTERNAL FRICTION ANGLE (φ) (DEGREES)	COHESION (c)
REINFORCED FILL	*	0
RETAINED SOIL	125	28 0
FOUNDATION SOIL	125	28

* DETERMINED DURING WALL DESIGN BASED ON PROPOSED BACKFILL MATERIAL.
3. WALL DESIGN TO INCLUDE AN EVALUATION OF THE GLOBAL STABILITY OF THE PROPOSED WALL, TAKING INTO ACCOUNT THE EXISTING SLOPE (3:1 MAX.) AT THE TOE OF THE PROPOSED WALL. PERFORM THE INTERNAL AND EXTERNAL STABILITY ANALYSIS IN ACCORDANCE WITH THE "NCMA DESIGN MANUAL FOR SEGMENTAL RETAINING WALLS", USING THE RECOMMENDED MINIMUM FACTORS OF SAFETY IN THIS MANUAL.


4. WALL DESIGN TO INCLUDE 250 PSF LIVE LOAD SURCHARGE.

5. SEE GRADING PLAN FOR TOP AND BOTTOM OF WALL ELEVATIONS.

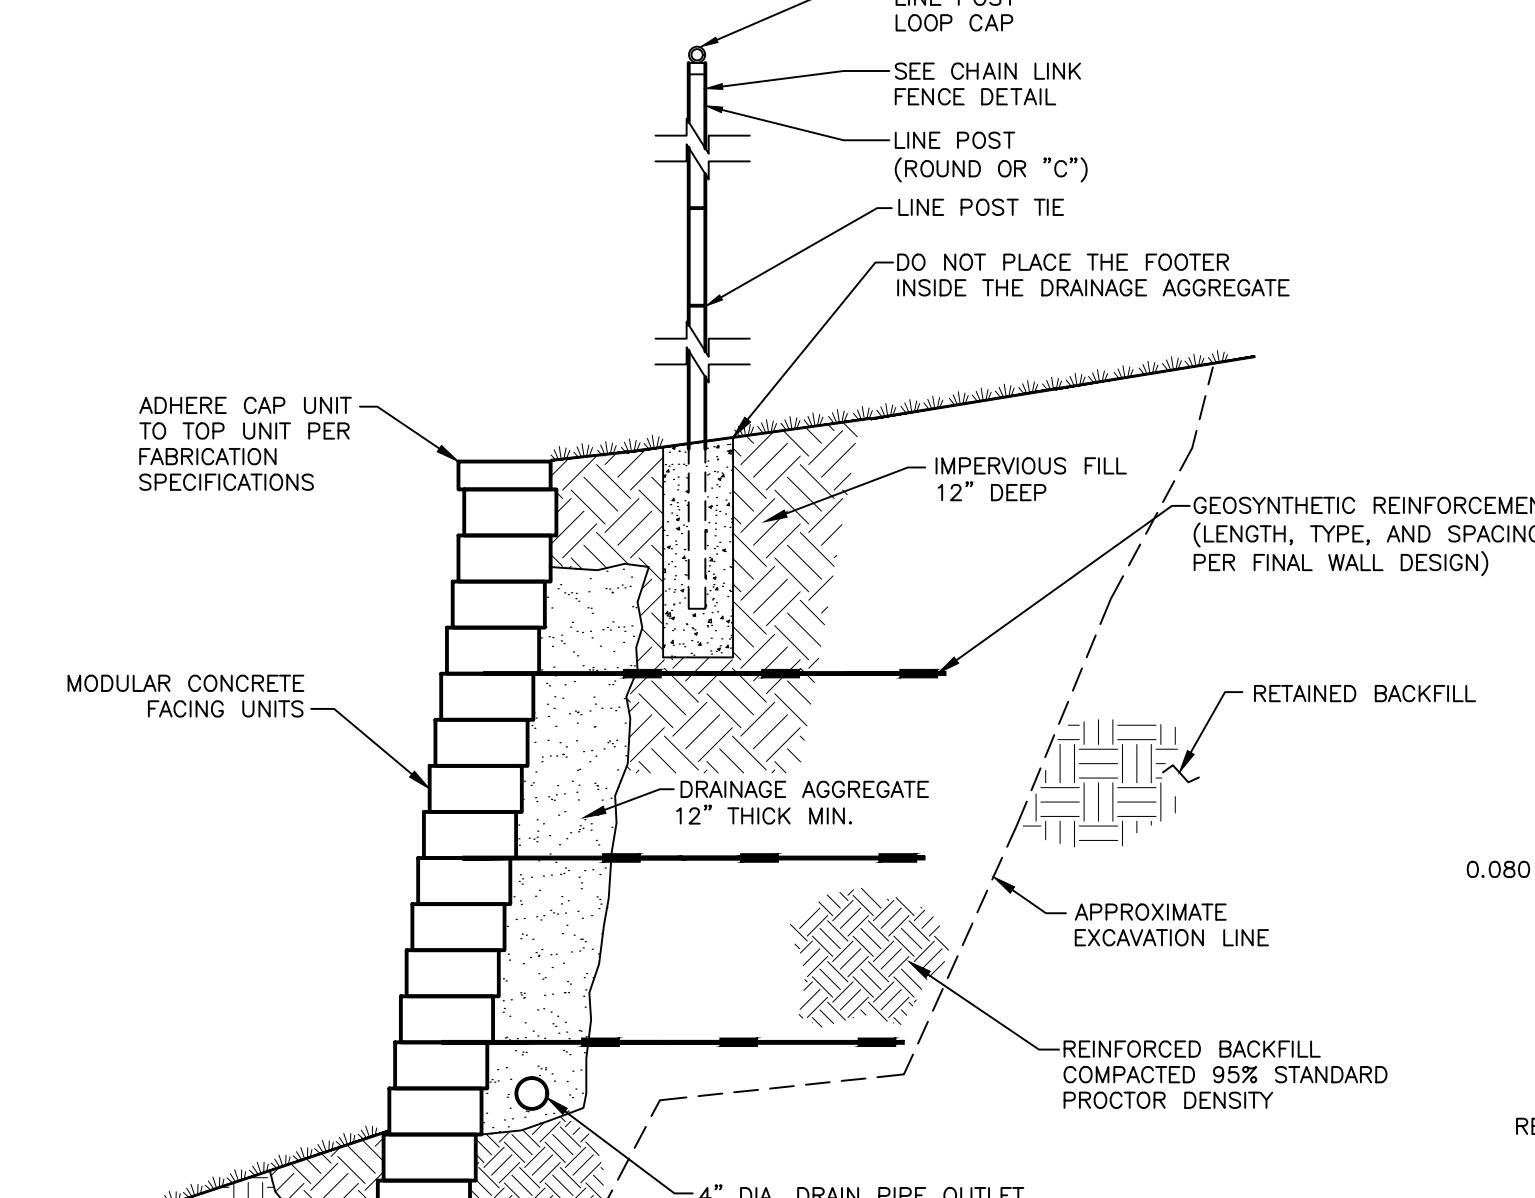


TYP. SECTION-SEGMENTAL RETAINING WALL

NOT TO SCALE

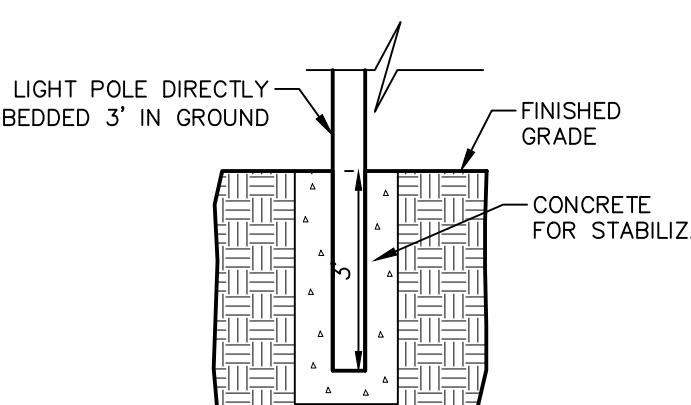


LIGHT POLE DETAIL

NOT TO SCALE

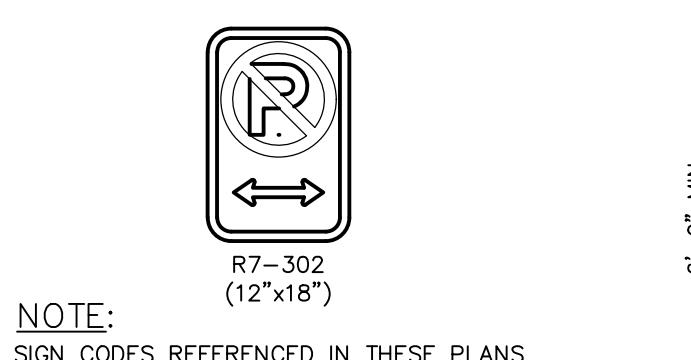

NO PARKING - R7-302

NOT TO SCALE

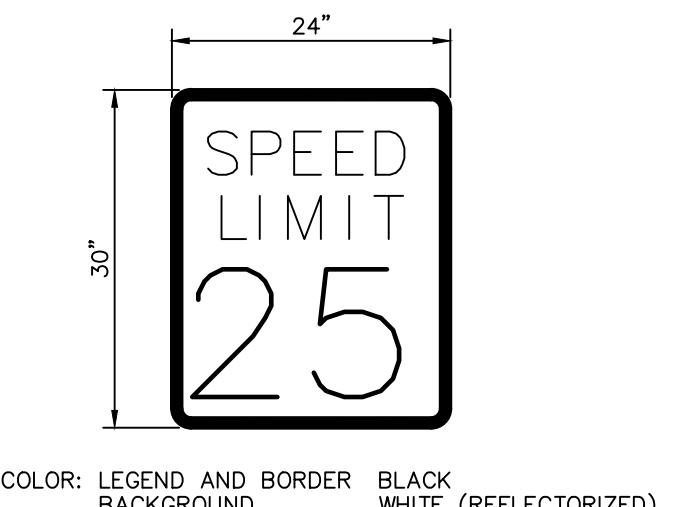


SPEED LIMIT SIGN - R2-1

NOT TO SCALE

CROSSWALK DETAIL


NOT TO SCALE

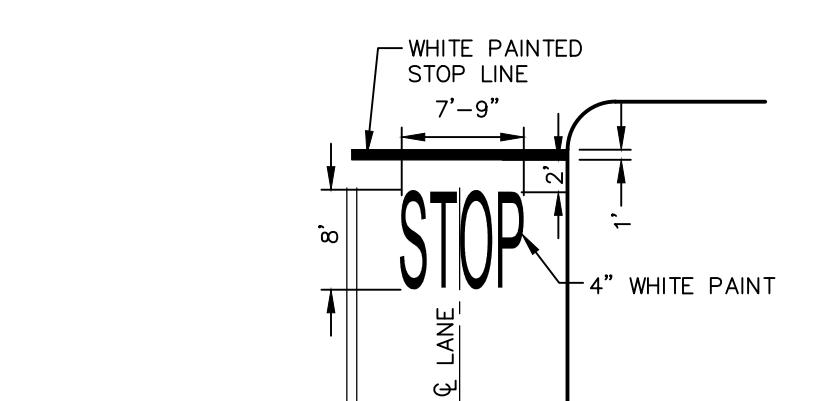

NOTES:
1. PAVEMENT MARKINGS TO BE INSTALLED IN LOCATIONS SHOWN ON THE PLANS.
2. MARKINGS SHALL BE THERMOPLASTIC.


STOP BAR DETAIL

NOT TO SCALE

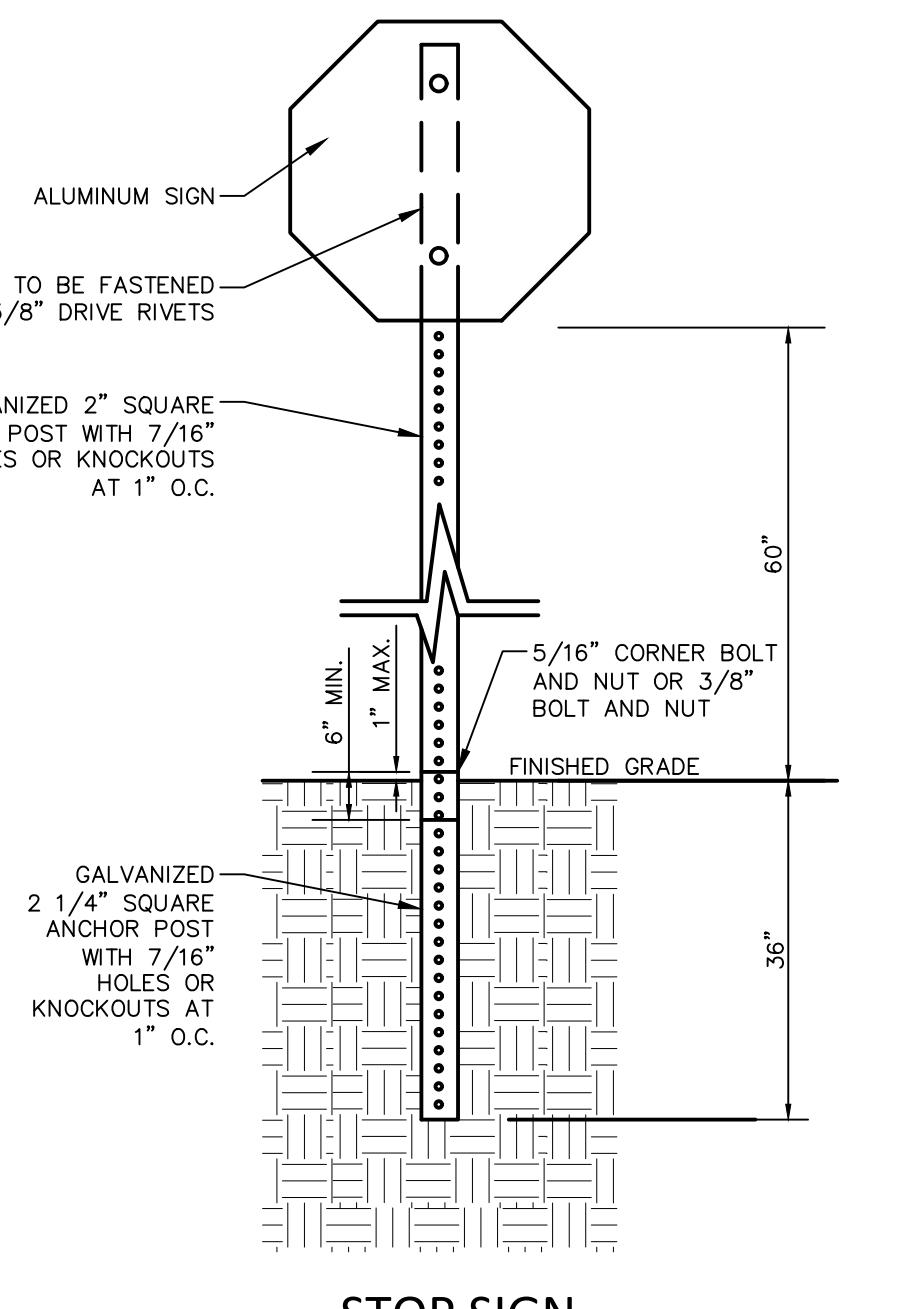



STOP SIGN

NOT TO SCALE

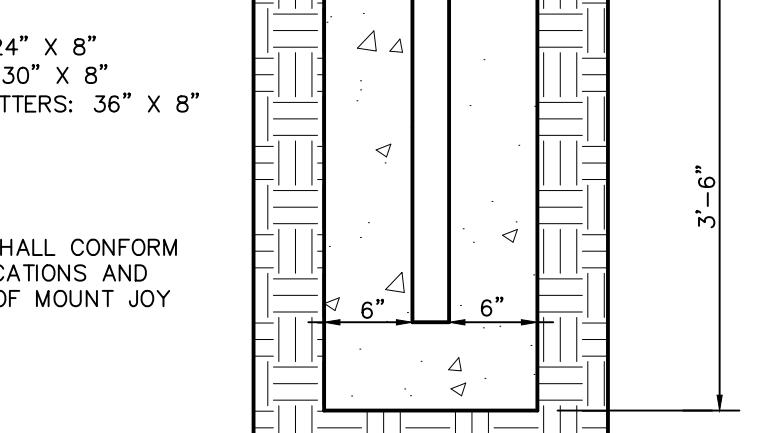


STREET IDENTIFICATION SIGN

NOT TO SCALE

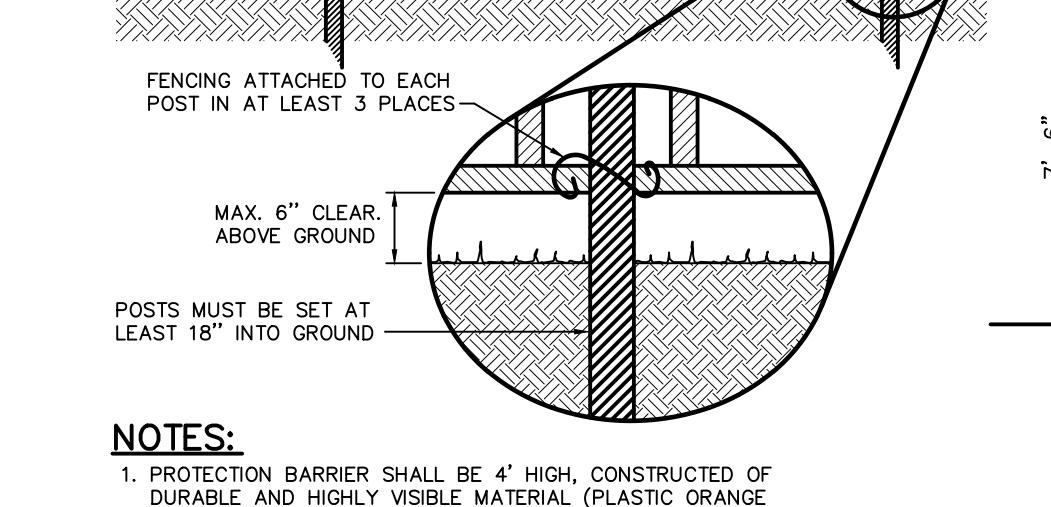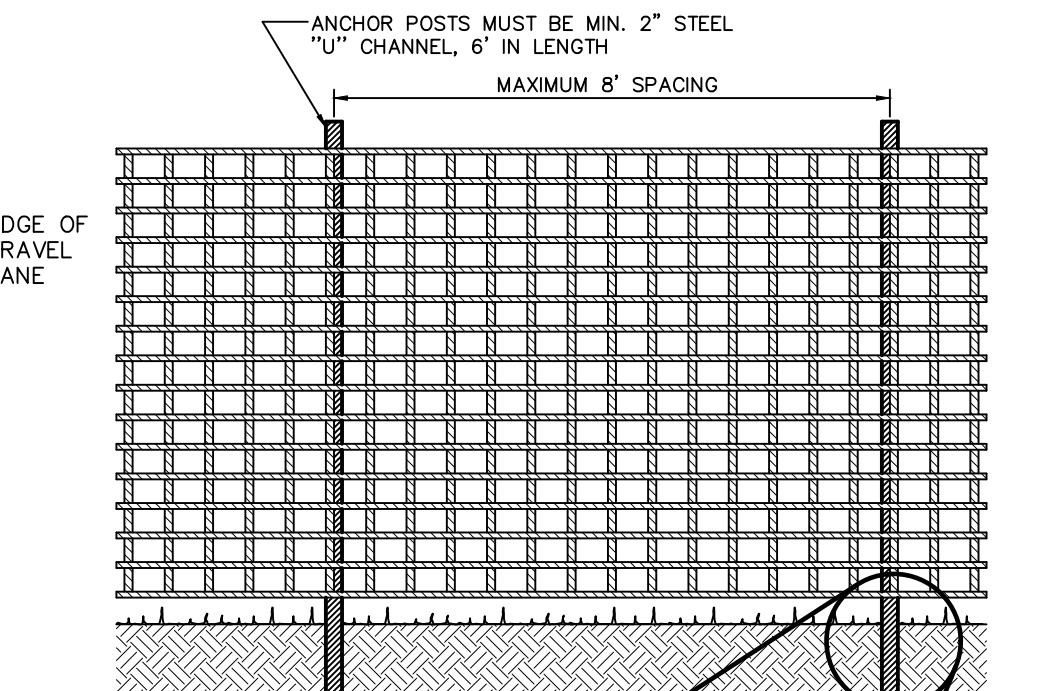


ORANGE CONSTRUCTION FENCE DETAIL

NOT TO SCALE

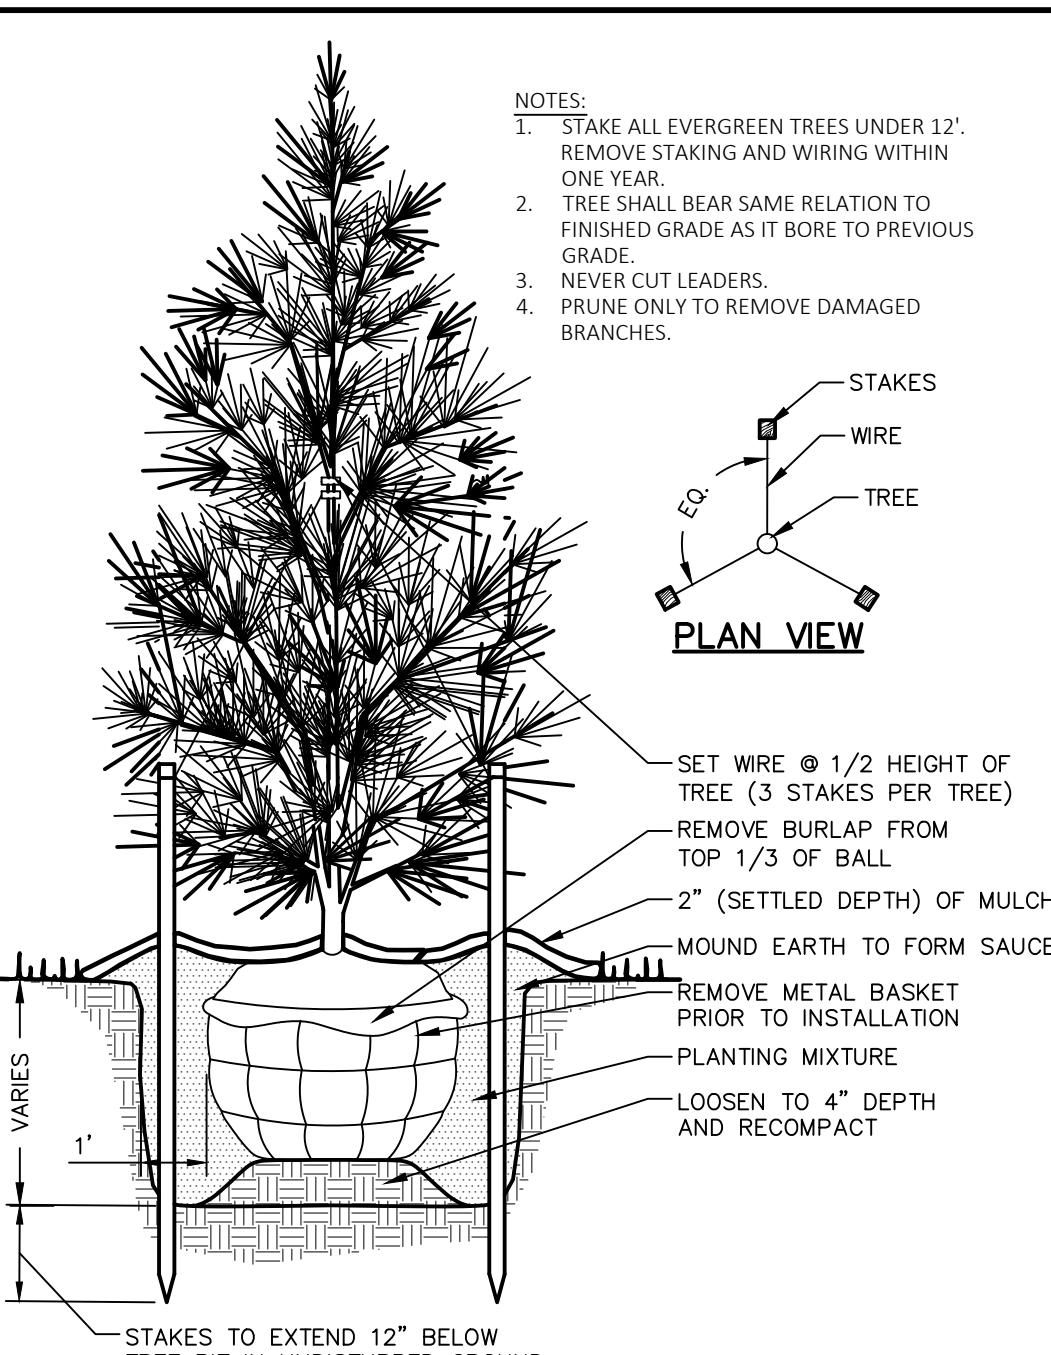


EVERGREEN TREE PLANTING

NOT TO SCALE

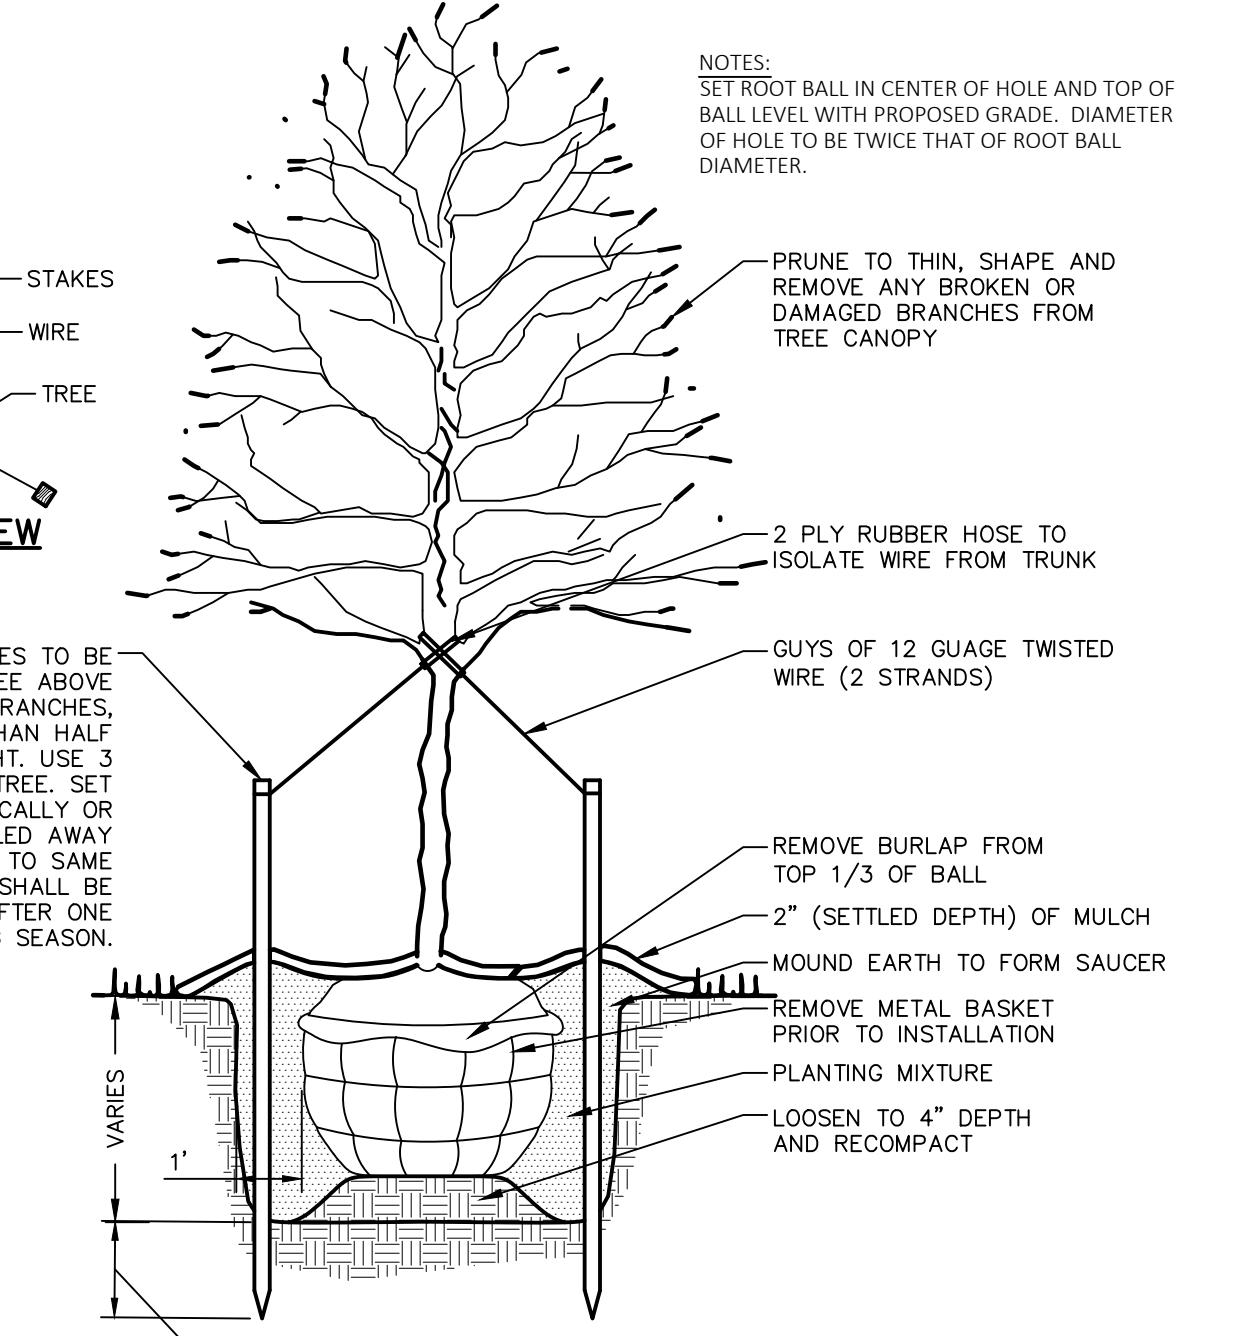


DECIDUOUS TREE PLANTING

NOT TO SCALE

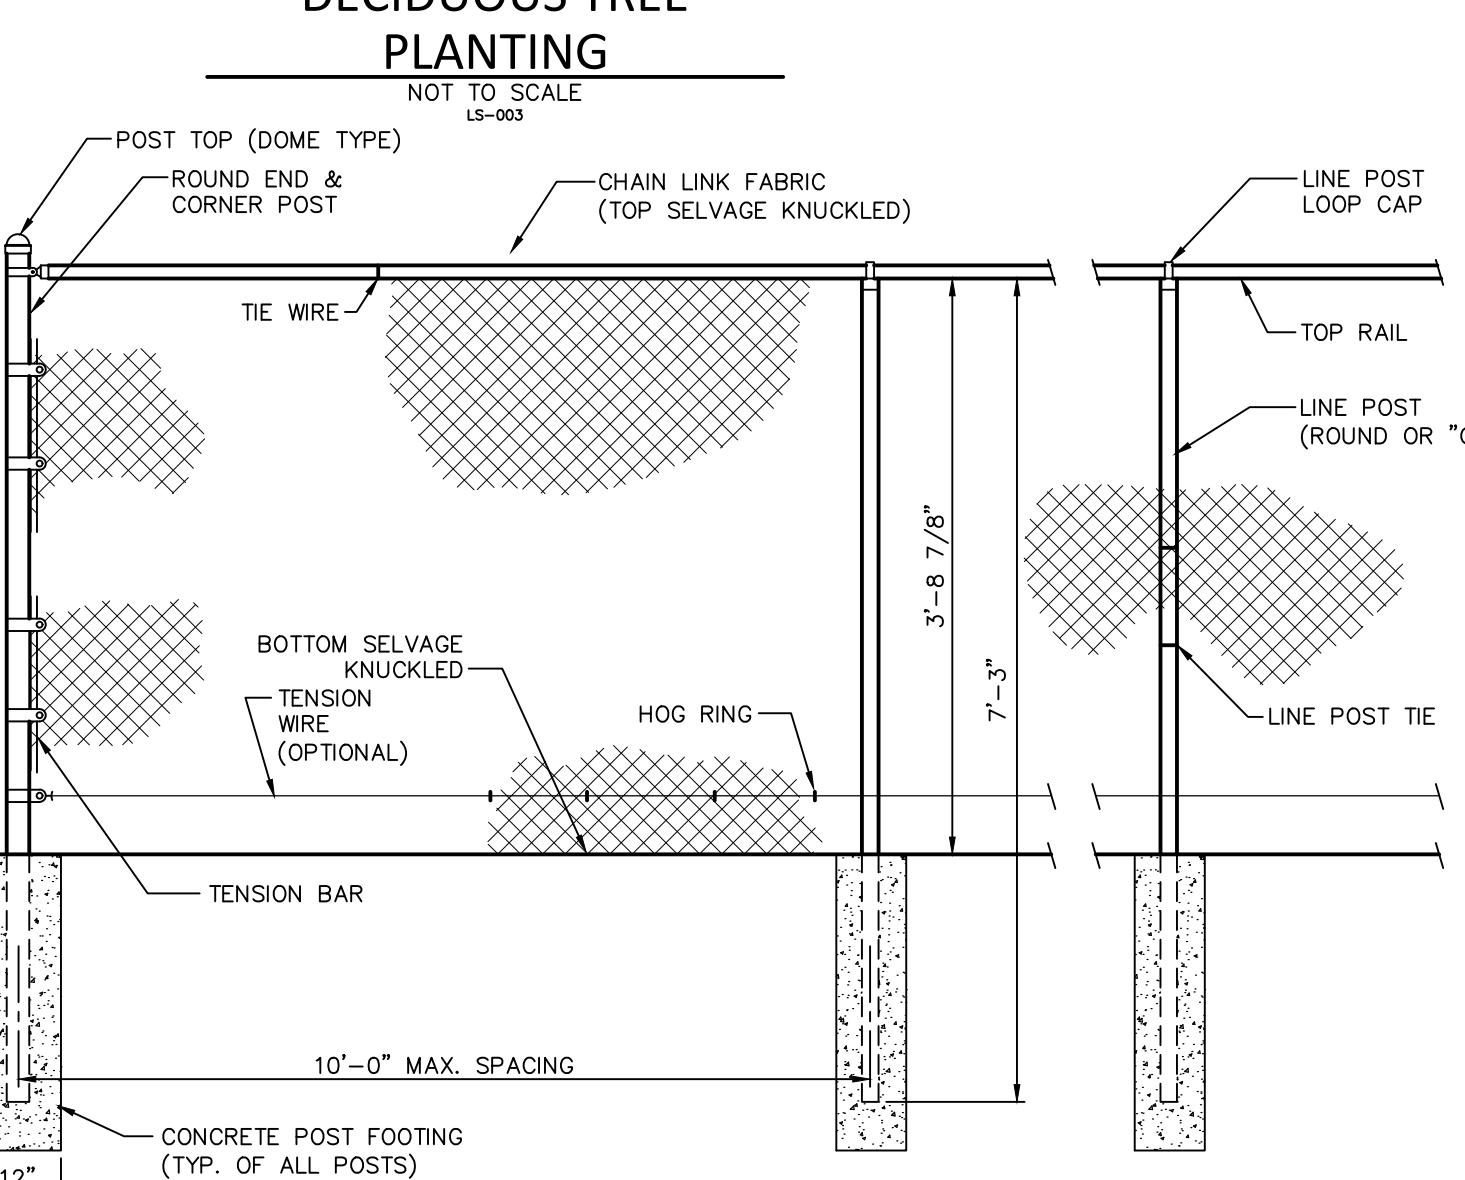


CHAIN LINK FENCE DETAIL - 4'-0"

NOT TO SCALE

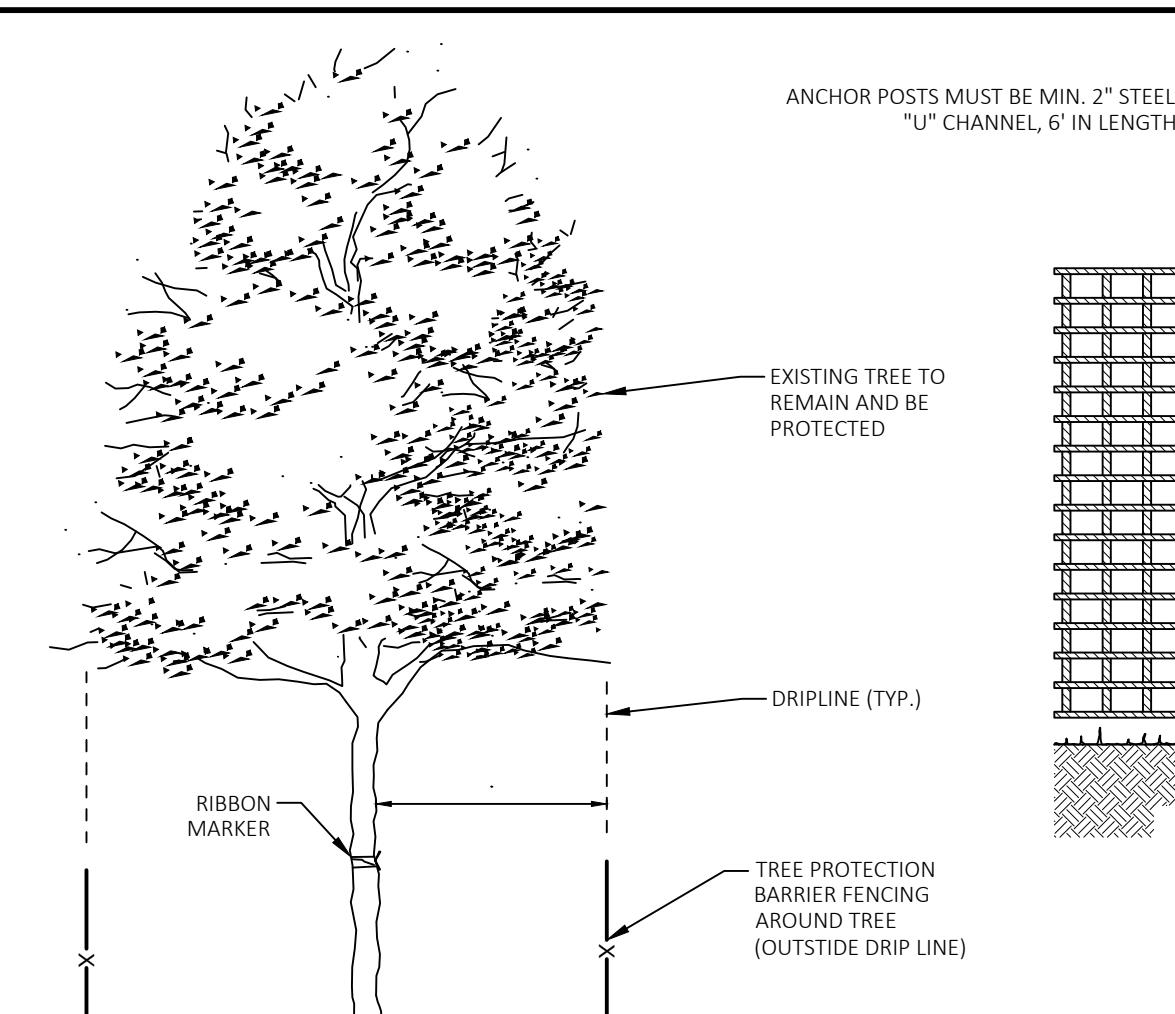

SECTION VIEW

NOTES:

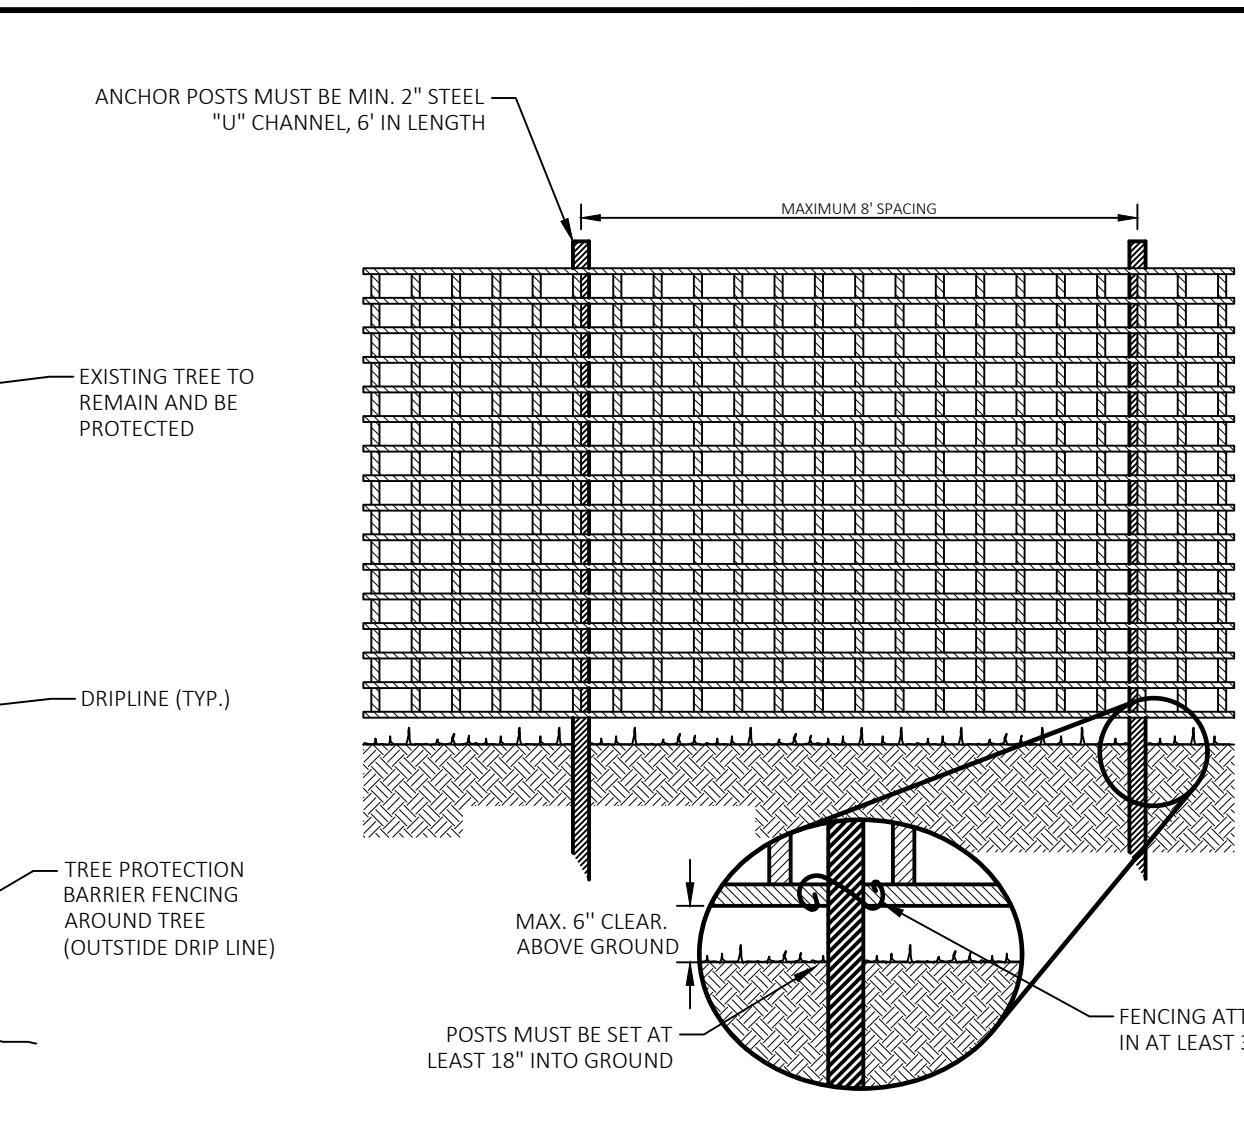

BARRIER FENCING

CLIENT	KGH DEVELOPMENT
DESIGN BY:	JAR
FIELDBOOK NO:	(717) 560-9095
SURV. CHIEF:	AJM
DRAWN BY:	JAR
DRAWING REFERENCE:	TempCAD System (Softree v10.0/Updated TempCAD) LSPDWS-AFD-71540-01979200-Final Plan-Phase 1
DATE:	4/12/24

REVIEW


RETTIEW Assisted Inc., Lancaster, PA 17603

Phone: (800) 738-8395

Website: www.rettiew.com

DETAILS

FINAL LAND DEVELOPMENT, SUBDIVISION, AND LOT ADD-ON PLAN FOR RAFFENSPERGER - PHASE 1
NOTICE: By signing or stamping your name below, you are indicating that you have read and understood the terms and conditions contained in the attached Agreement for Construction Services and that you are willing to be bound by them.
DATE: 4/12/24
SHEET NO. 26 of 33
DWG. NO. 01979200

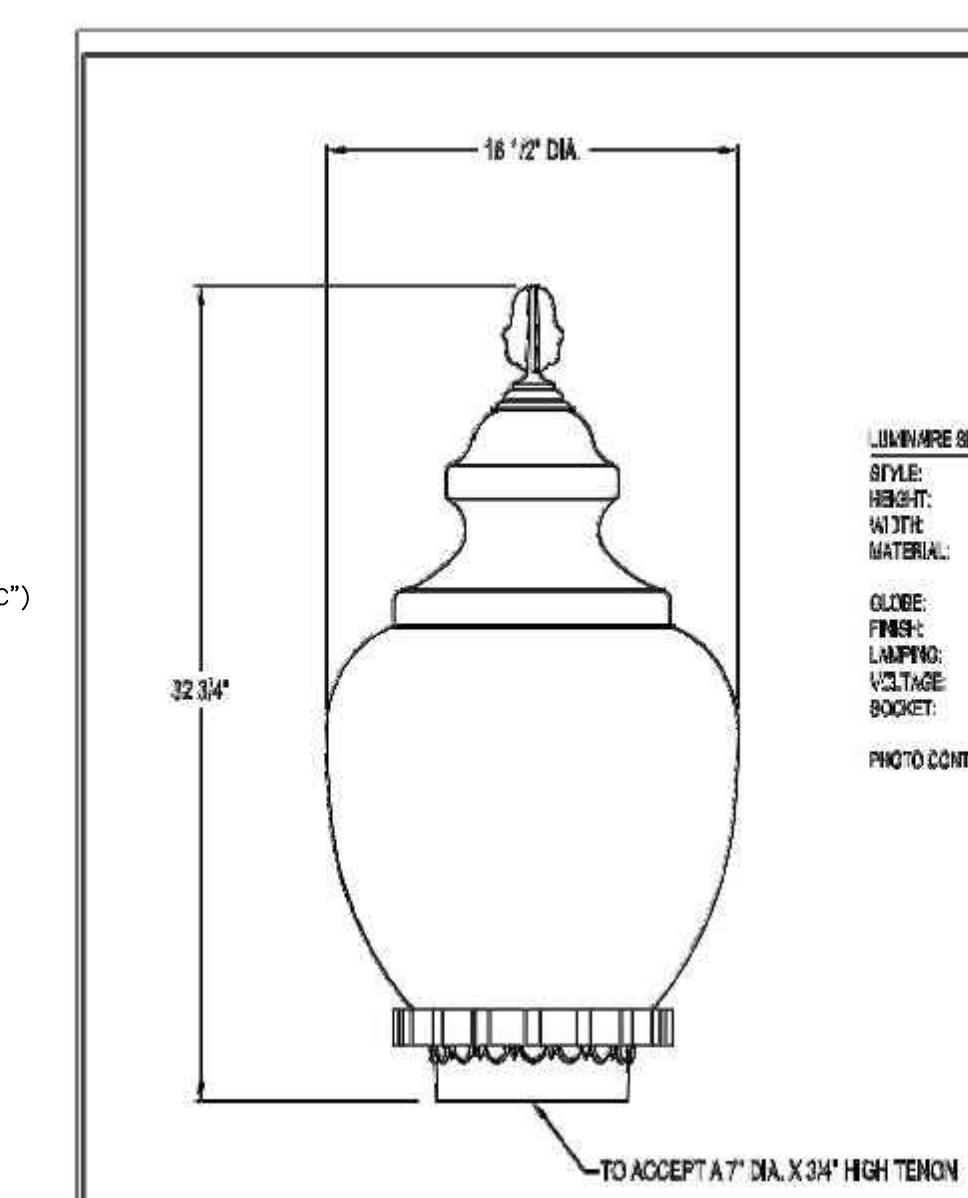

LIGHTING DETAIL


NOT TO SCALE


Spring City Electrical Mfg. Co.


HALL AND HORN STREET - P.O. BOX 10 - SPRING CITY, PA 19475
PHONE: (800) 384-4000 FAX: (619) 945-2777
E-mail Address: sales@springcity.com


DESCRIPTION: L161-LP81-FP3 POF

NOT FOR CONSTRUCTION/NOT FOR BIDDING

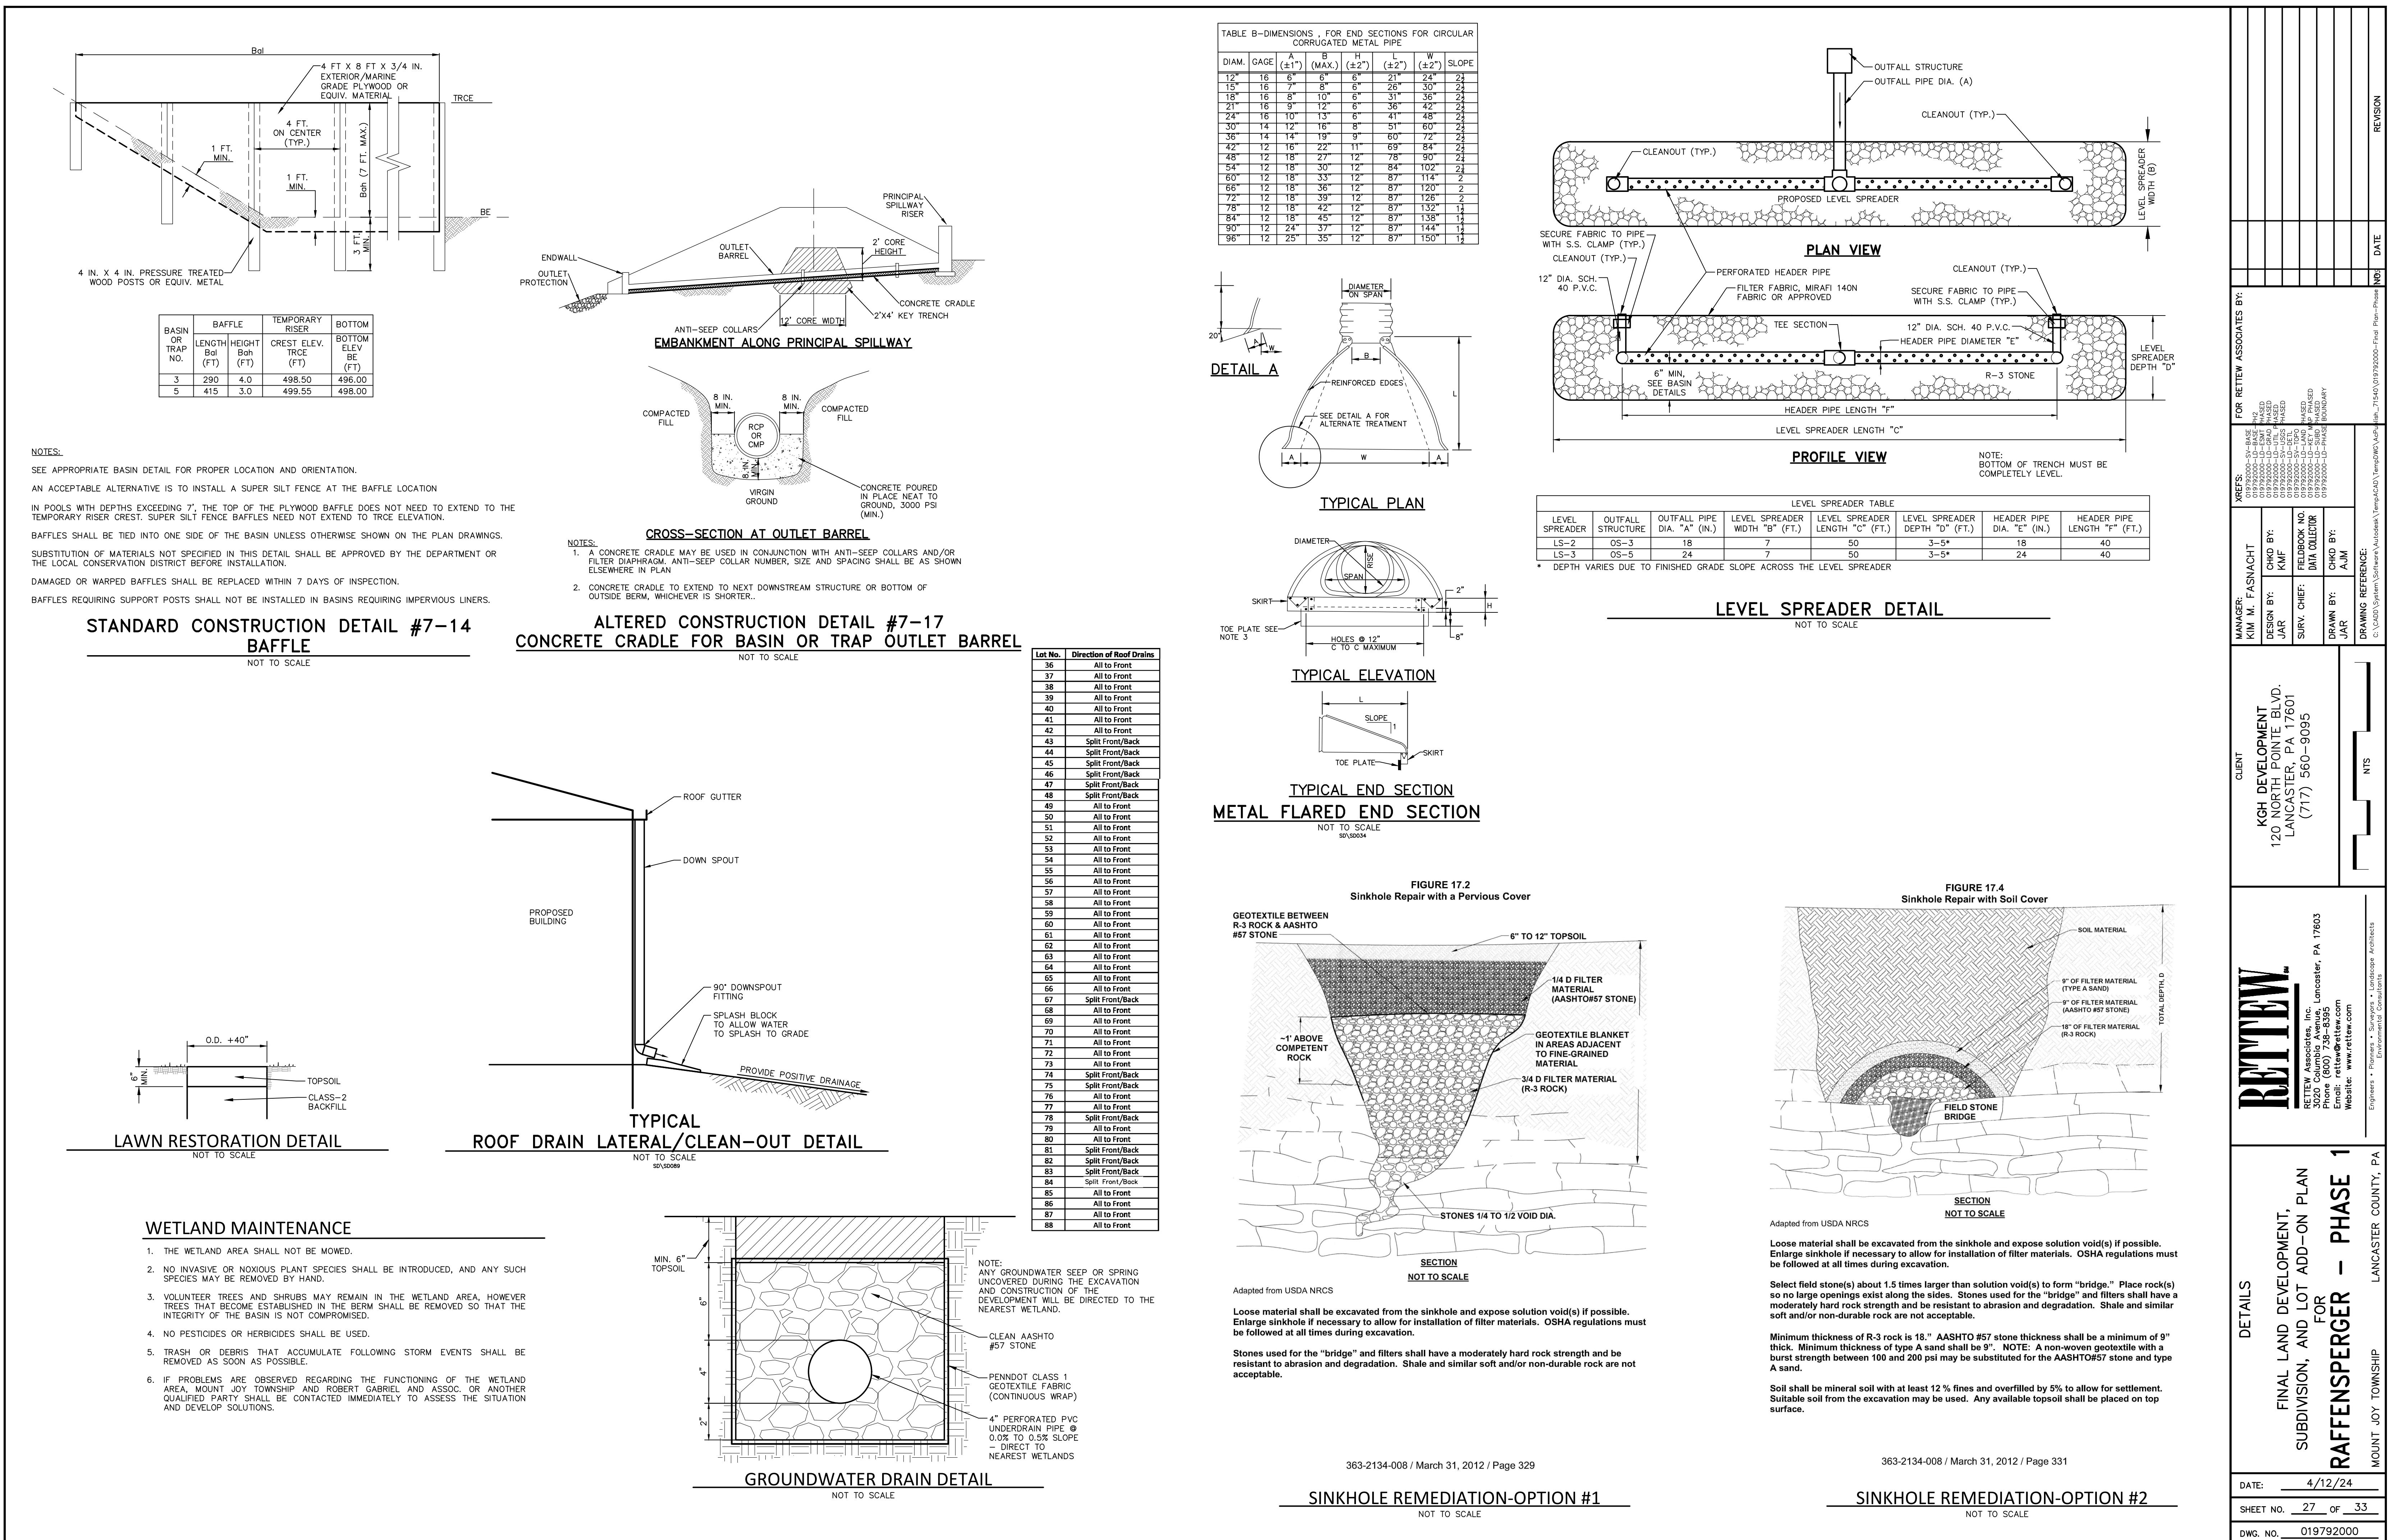

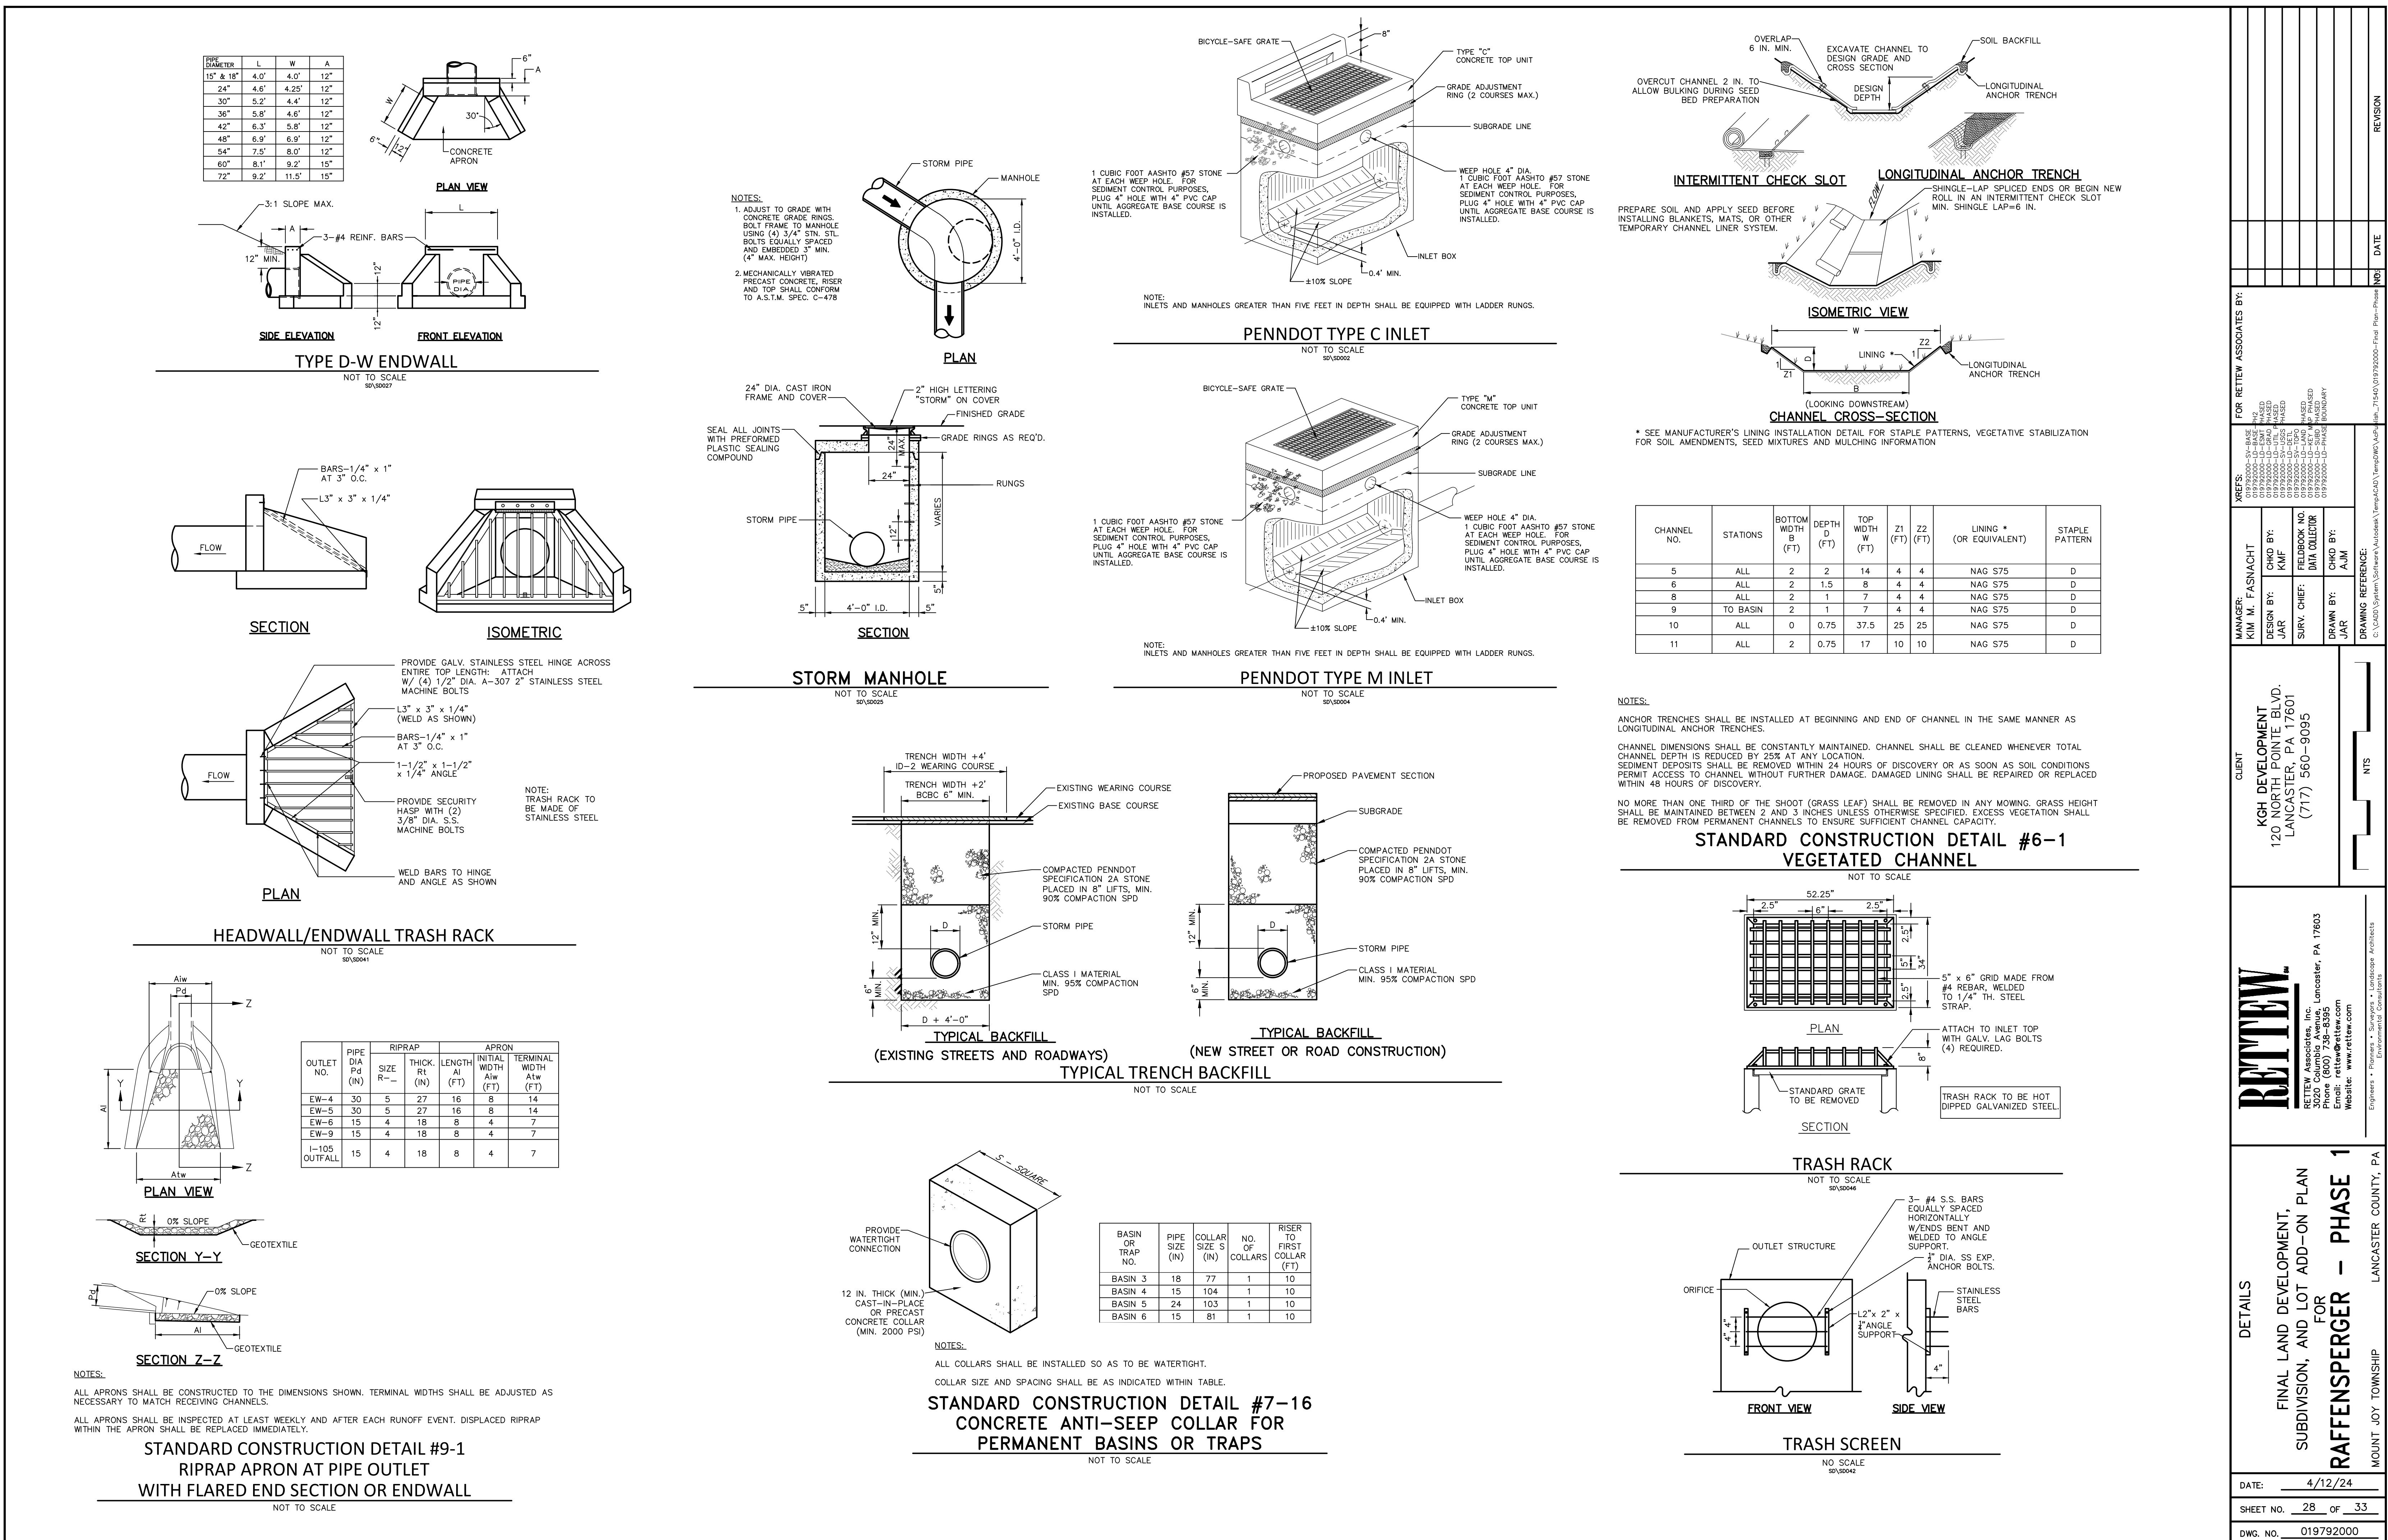


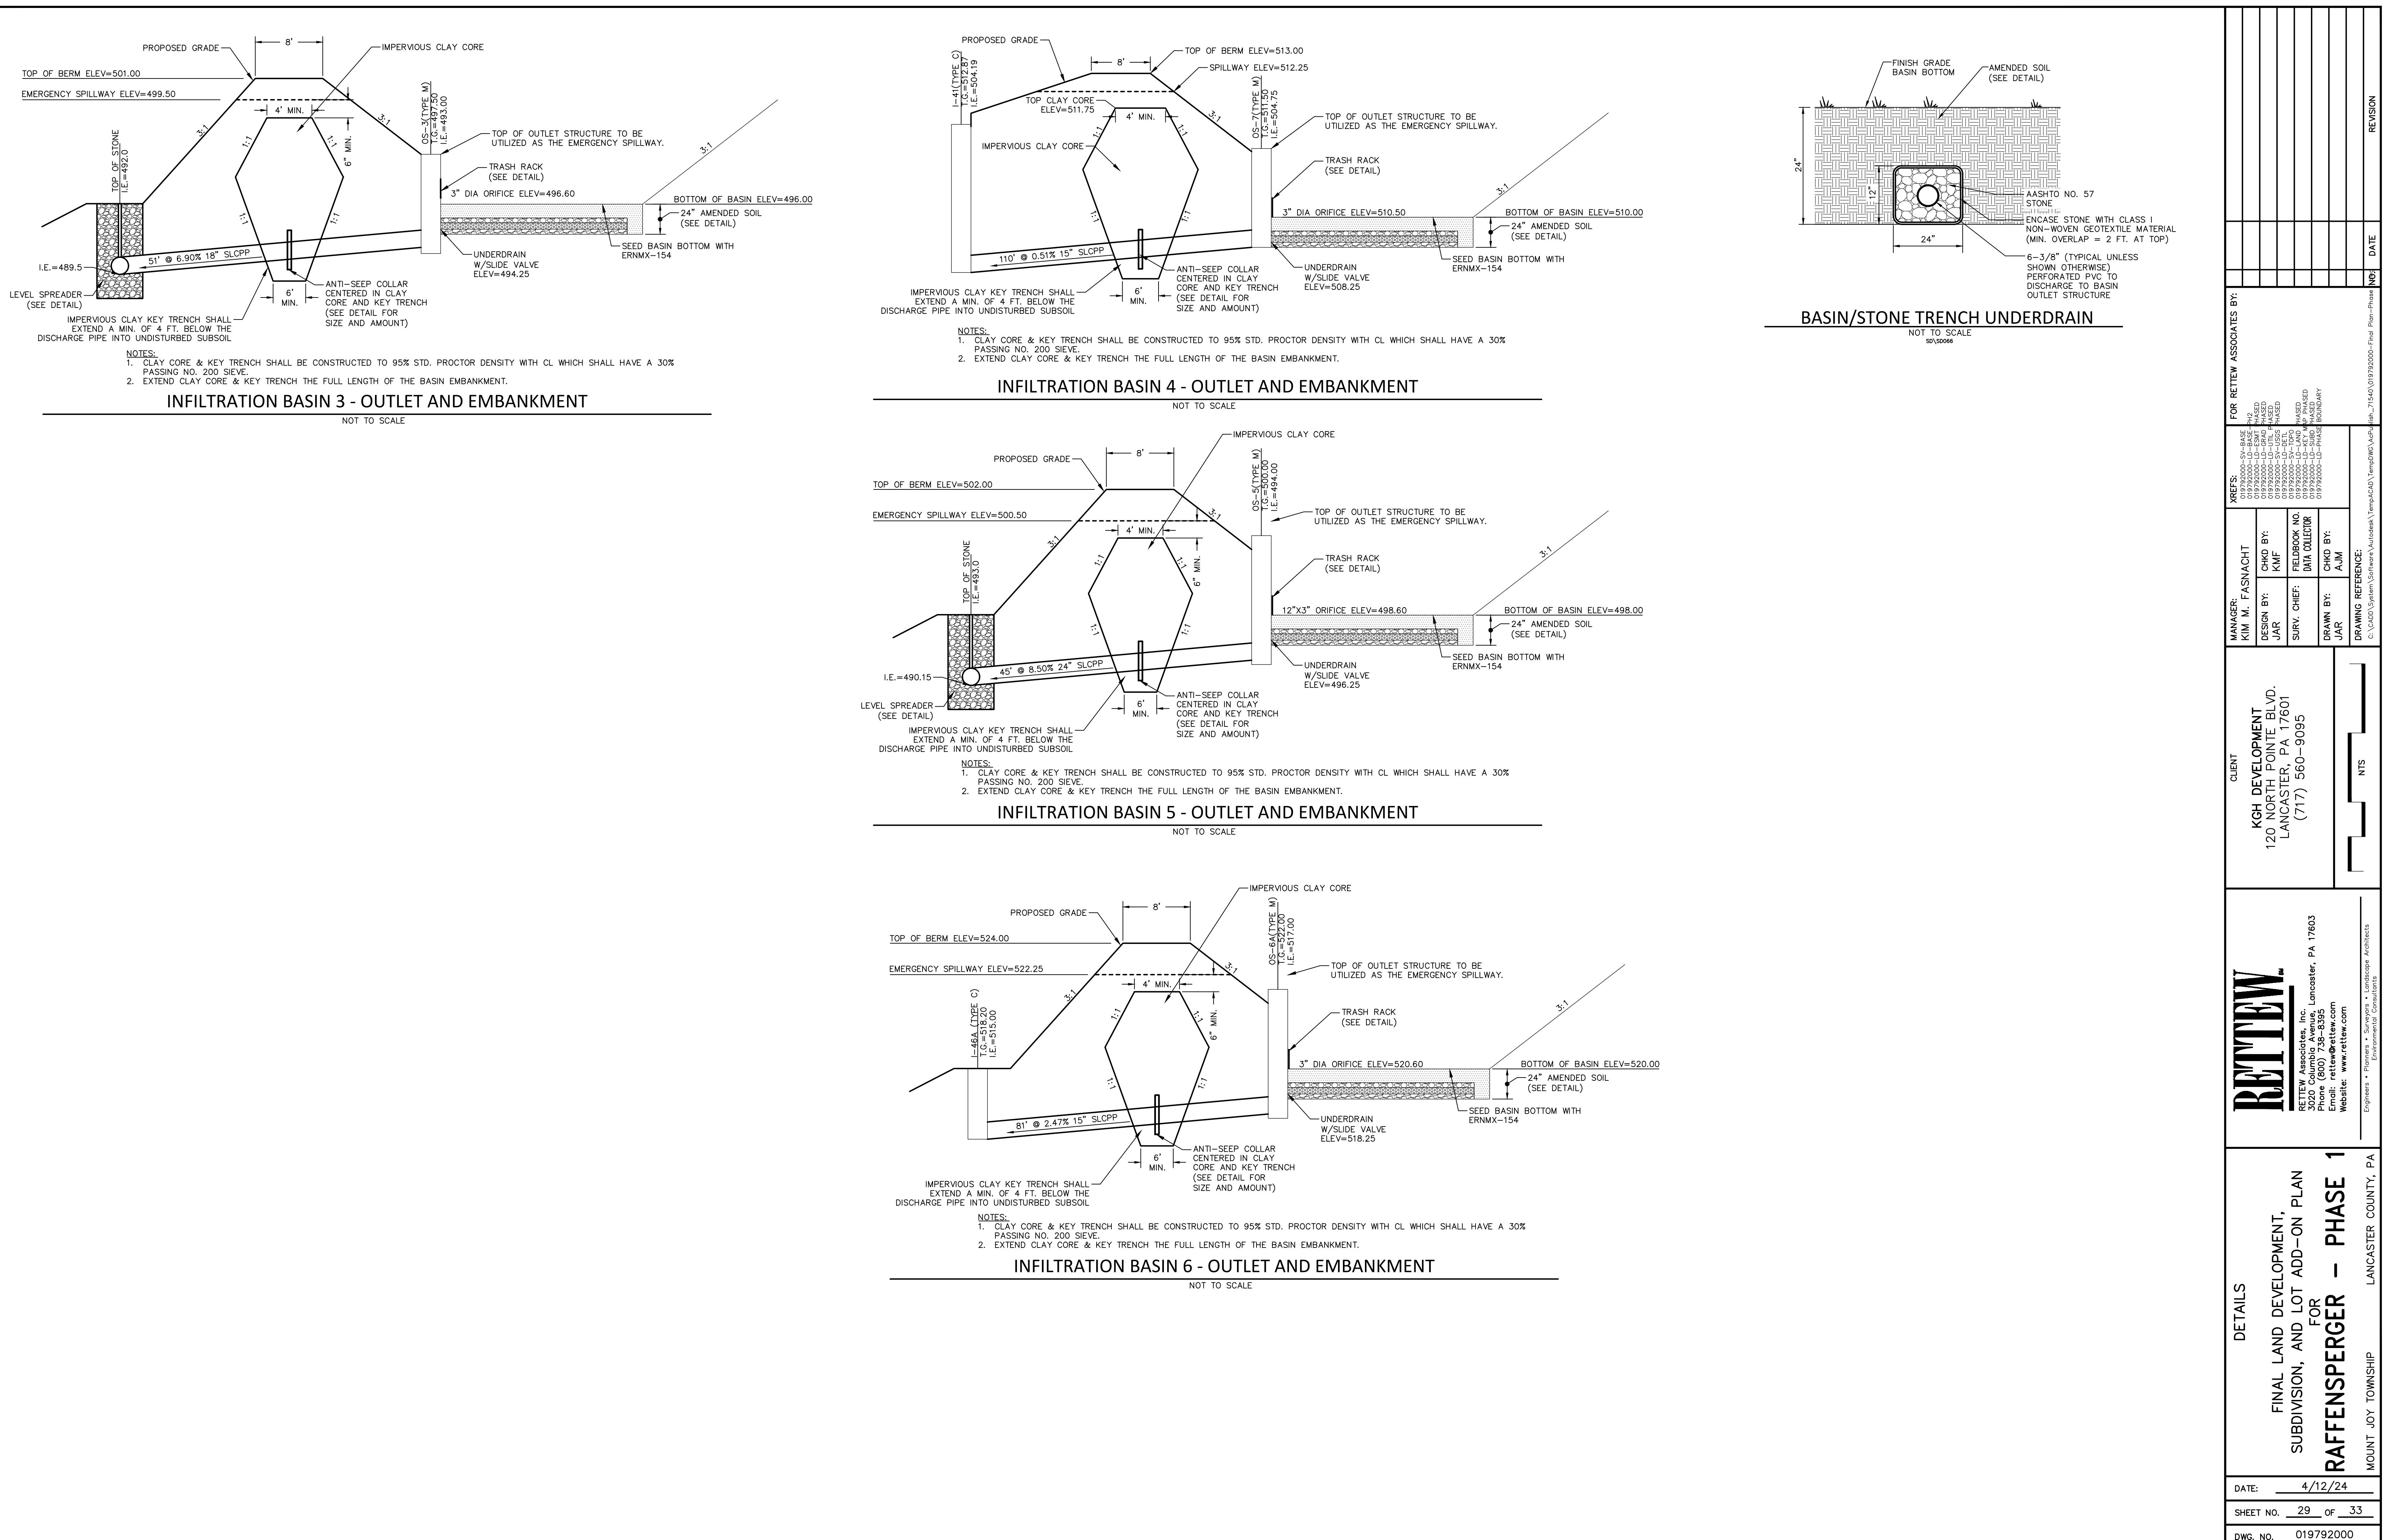

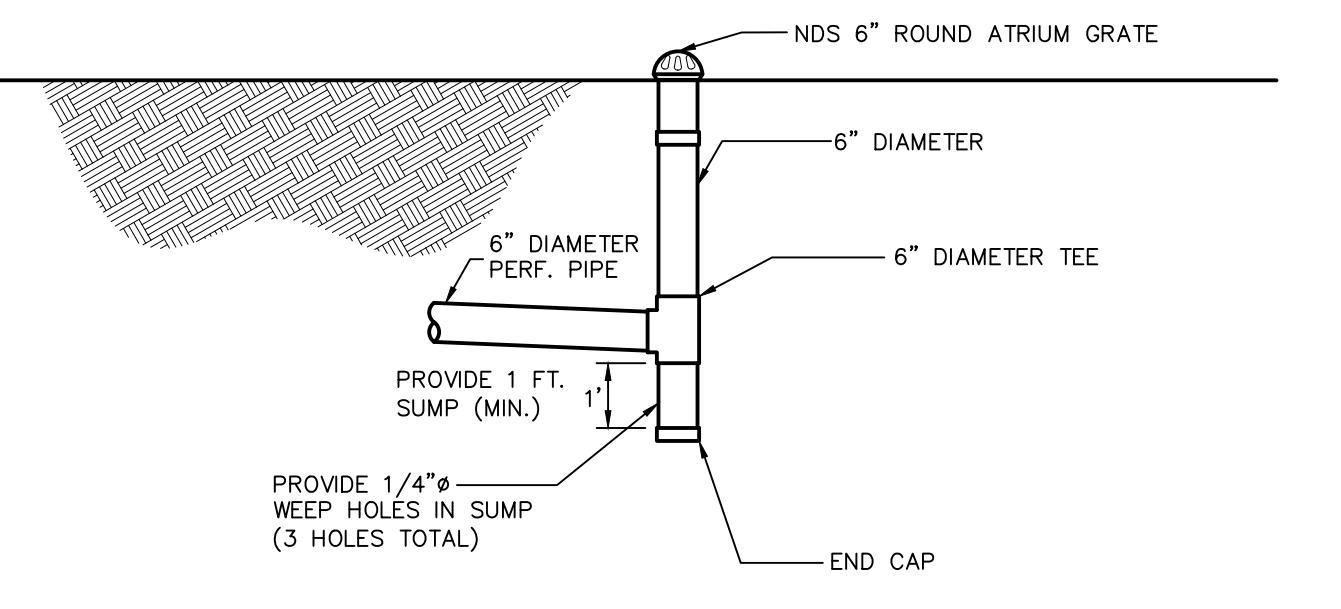

**TYPICAL
IN-LINE CLEAN-OUT DETAIL**

NOT TO SCALE
SDS098

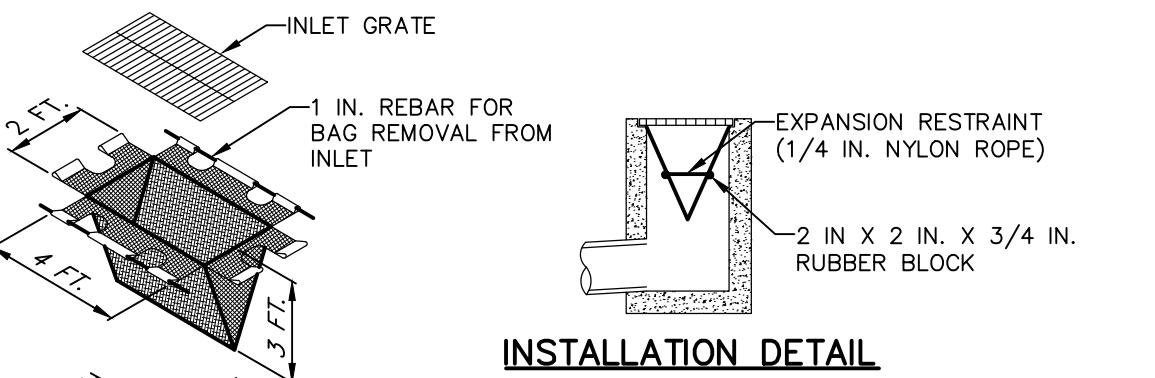

INSTALLATION DETAIL

ISOMETRIC VIEW

SECTION VIEW

PLAN VIEW

NOTES:

MAXIMUM DRAINAGE AREA = 1/2 ACRE.

INLET PROTECTION SHALL NOT BE REQUIRED FOR INLET TRIBUTARY TO SEDIMENT BASIN OR TRAP. BERMS SHALL BE REQUIRED FOR ALL INSTALLATIONS.

ROLLED EARTHEN BERM IN ROADWAY SHALL BE MAINTAINED UNTIL ROADWAY IS STONED. ROAD SUBBASE BERM ON ROADWAY SHALL BE MAINTAINED UNTIL ROADWAY IS PAVED. EARTHEN BERM IN CHANNEL SHALL BE MAINTAINED UNTIL PERMANENT STABILIZATION IS COMPLETED OR REMAIN PERMANENTLY.


AT A MINIMUM, THE FABRIC SHALL HAVE A MINIMUM GRAB TENSILE STRENGTH OF 120 LBS, A MINIMUM BURST STRENGTH OF 200 PSI, AND A MINIMUM TRAPEZOIDAL TEAR STRENGTH OF 50 LBS. FILTER BAGS SHALL BE CAPABLE OF TRAPPING ALL PARTICLES NOT PASSING A NO. 40 SIEVE.

INLET FILTER BAGS SHALL BE INSPECTED ON A WEEKLY BASIS AND AFTER EACH PUNOOF EVENT. BAGS SHALL BE EMPTIED AND RINSED OR REPLACED WHEN HALF FULL OR WHEN FLOW CAPACITY HAS BEEN REDUCED SO AS TO CAUSE FLOODING OR BYPASSING OF THE INLET. DAMAGED OR CLOGGED BAGS SHALL BE REPLACED. A SUPPLY SHALL BE MAINTAINED ON SITE FOR REPLACEMENT BAGS. ALL NEEDED REPAIRS SHALL BE INITIATED IMMEDIATELY AFTER THE INSPECTION. DISPOSE ACCUMULATED SEDIMENT AS WELL AS ALL USED BAGS ACCORDING TO THE PLAN NOTES.

DO NOT USE ON MAJOR PAVED ROADWAYS WHERE PONDING MAY CAUSE TRAFFIC HAZARDS.

**STANDARD CONSTRUCTION DETAIL #4-16
FILTER BAG INLET PROTECTION - TYPE M INLET**

NOT TO SCALE

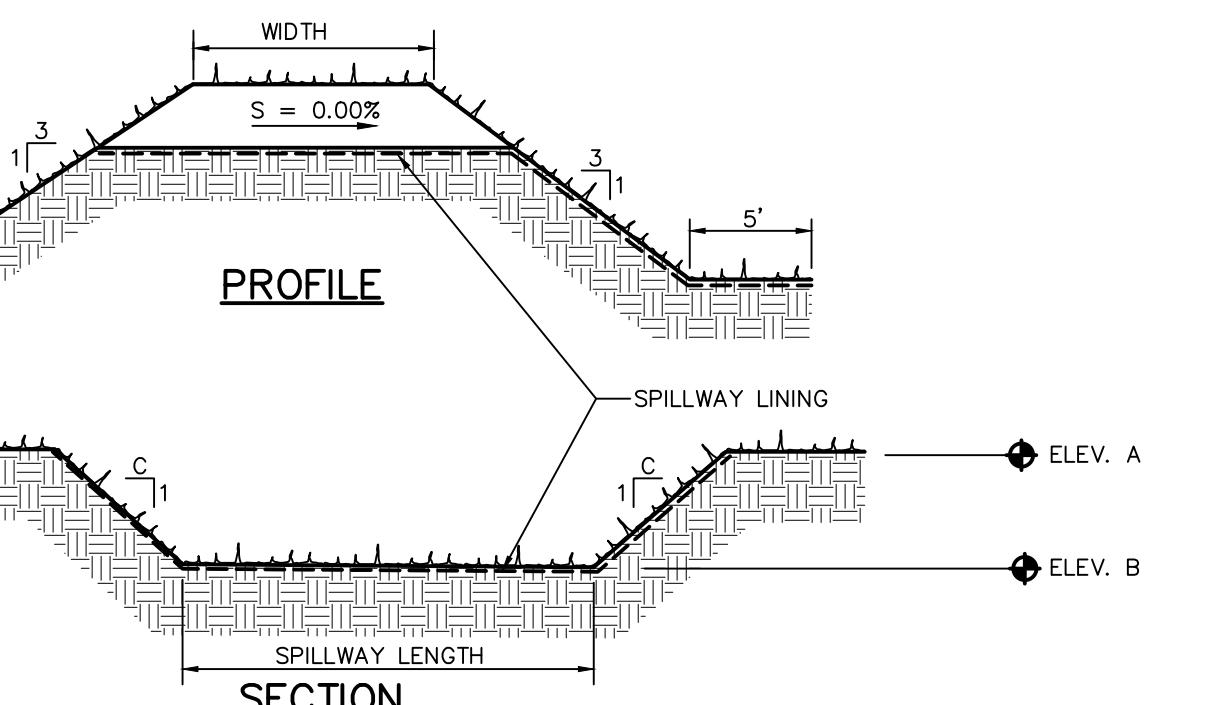


BASIN	TOP OF BERM ELEV. A	SPILLWAY ELEV. B	SLOPE C	SPILLWAY LENGTH(FT)	BERM WIDTH(FT)	SPILLWAY LINING
BASIN 3	501.00	499.50	3	50	8	NAG SC150
BASIN 4*	513.00	512.25	3	12	6	NAG DS75
BASIN 5	502.00	500.50	3	50	8	NAG C350
BASIN 6	524.00	522.25	3	25	6	NAG S150

NOTES:

- * CONSISTS OF TWO 6' WIDE CHANNELS BETWEEN LOTS


EMERGENCY SPILLWAY

NOT TO SCALE
SDS098

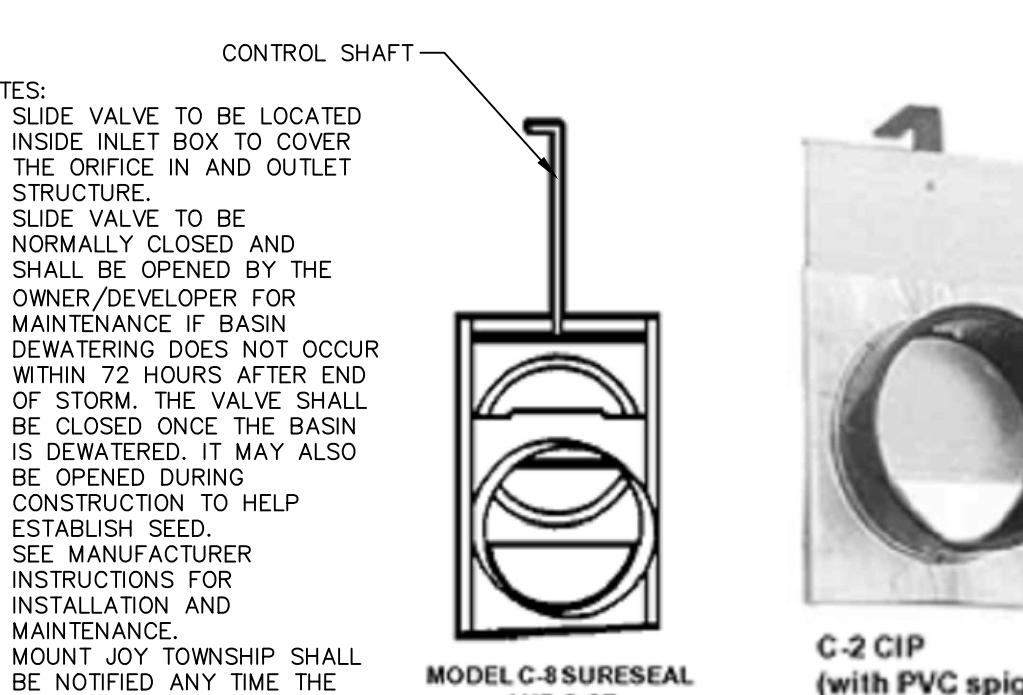

SLIDE VALVE

NOT TO SCALE
SDS098
NOTE: THE SLIDE IS TO BE INSTALLED IN ALL OUTLET STRUCTURES ASSOCIATED WITH THE INFILTRATION BASINS AND RAIN GARDEN.









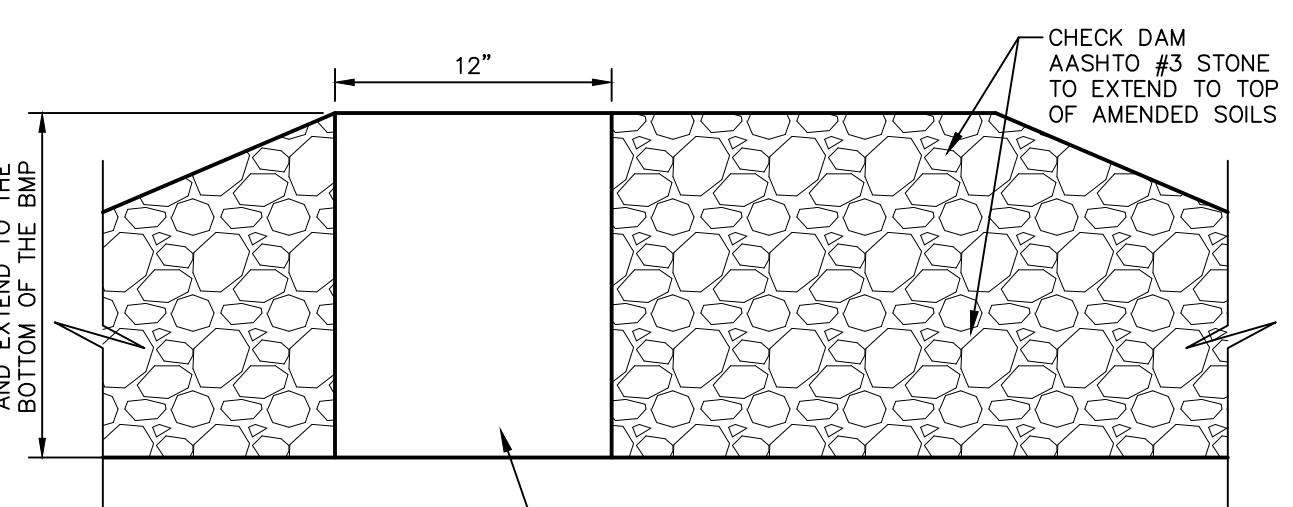






NOTE:
CLAY DIKE SHALL CONSIST OF CLAY CONTAINING NO MORE THAN 15% (BY VOLUME) STONE NO LARGER THAN TWO (2) INCHES IN DIAMETER. CLAY SHALL BE PLACED IN SIX (6) INCH LIFTS AND COMPACTED BY A MECHANICAL TAMPER TO NOT LESS THAN 95% OF MAXIMUM DENSITY AT OPTIMUM MOISTURE CONTENT.

CLAY DIKE DETAIL

NOT TO SCALE
G-013

CLIENT	KGH DEVELOPMENT 120 NORTH POINTE BLVD. LANCASSTER, PA 17601 (717) 560-9095	FOR RETTEW ASSOCIATES BY:
MANAGER:	KIM M. FASNACH-T	XREFS: 019792000-1-D-BASE-L-#2 019792000-1-D-BASE-L-#2 019792000-1-D-BASE-L-#3 019792000-1-D-BASE-L-#4 019792000-1-D-BASE-L-#5 019792000-1-D-BASE-L-#6 019792000-1-D-BASE-L-#7 019792000-1-D-BASE-L-#8 019792000-1-D-BASE-L-#9 019792000-1-D-BASE-L-#10 019792000-1-D-BASE-L-#11 019792000-1-D-BASE-L-#12 019792000-1-D-BASE-L-#13 019792000-1-D-BASE-L-#14 019792000-1-D-BASE-L-#15 019792000-1-D-BASE-L-#16 019792000-1-D-BASE-L-#17 019792000-1-D-BASE-L-#18 019792000-1-D-BASE-L-#19 019792000-1-D-BASE-L-#20 019792000-1-D-BASE-L-#21 019792000-1-D-BASE-L-#22 019792000-1-D-BASE-L-#23 019792000-1-D-BASE-L-#24 019792000-1-D-BASE-L-#25 019792000-1-D-BASE-L-#26 019792000-1-D-BASE-L-#27 019792000-1-D-BASE-L-#28 019792000-1-D-BASE-L-#29 019792000-1-D-BASE-L-#30 019792000-1-D-BASE-L-#31 019792000-1-D-BASE-L-#32 019792000-1-D-BASE-L-#33 019792000-1-D-BASE-L-#34 019792000-1-D-BASE-L-#35 019792000-1-D-BASE-L-#36 019792000-1-D-BASE-L-#37 019792000-1-D-BASE-L-#38 019792000-1-D-BASE-L-#39 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019792000-1-D-BASE-L-#233 019792000-1

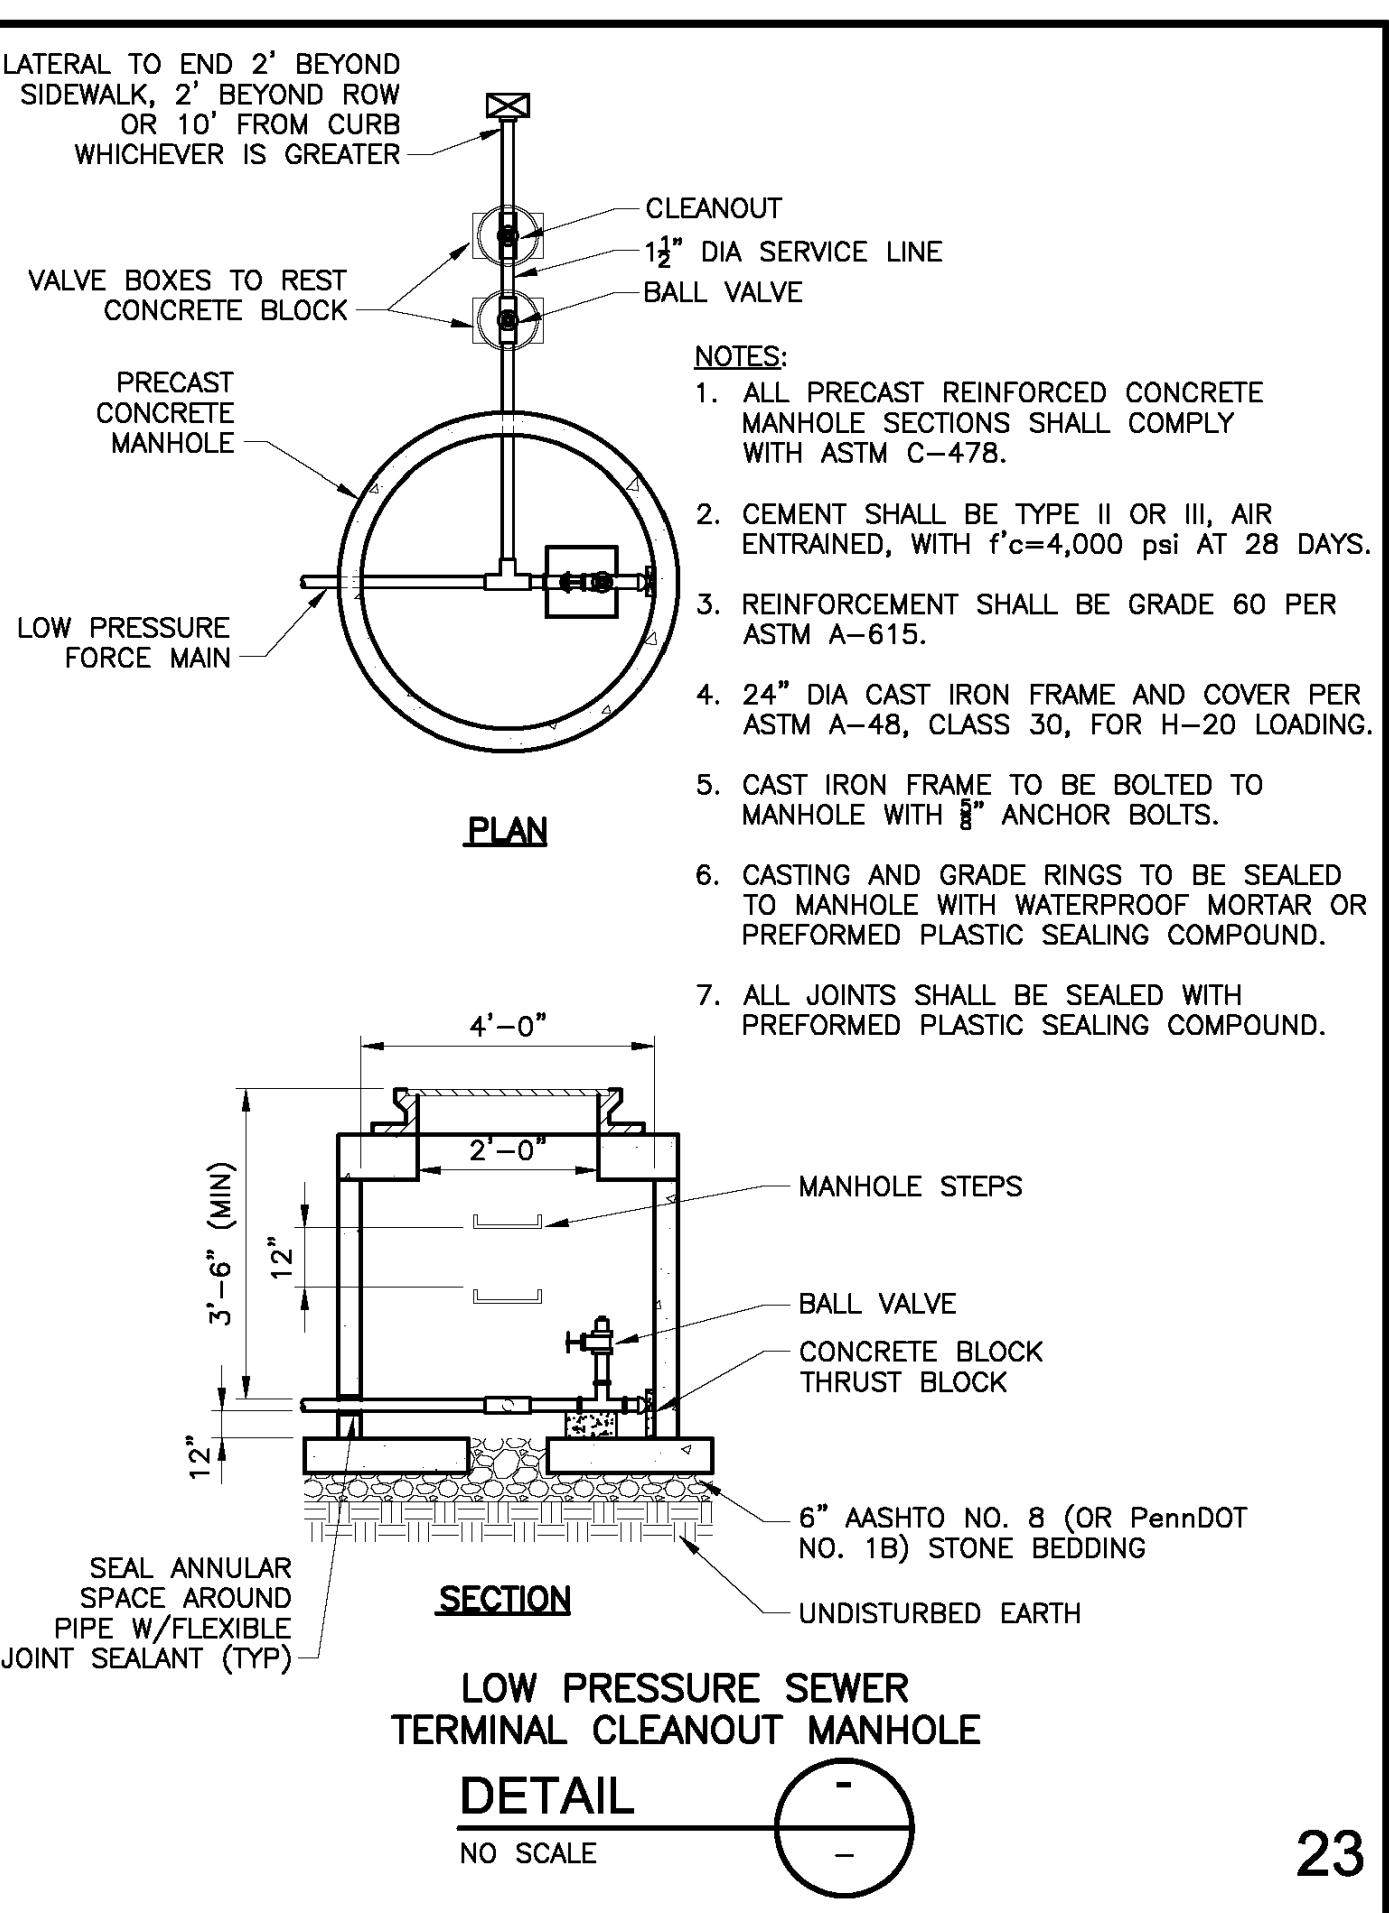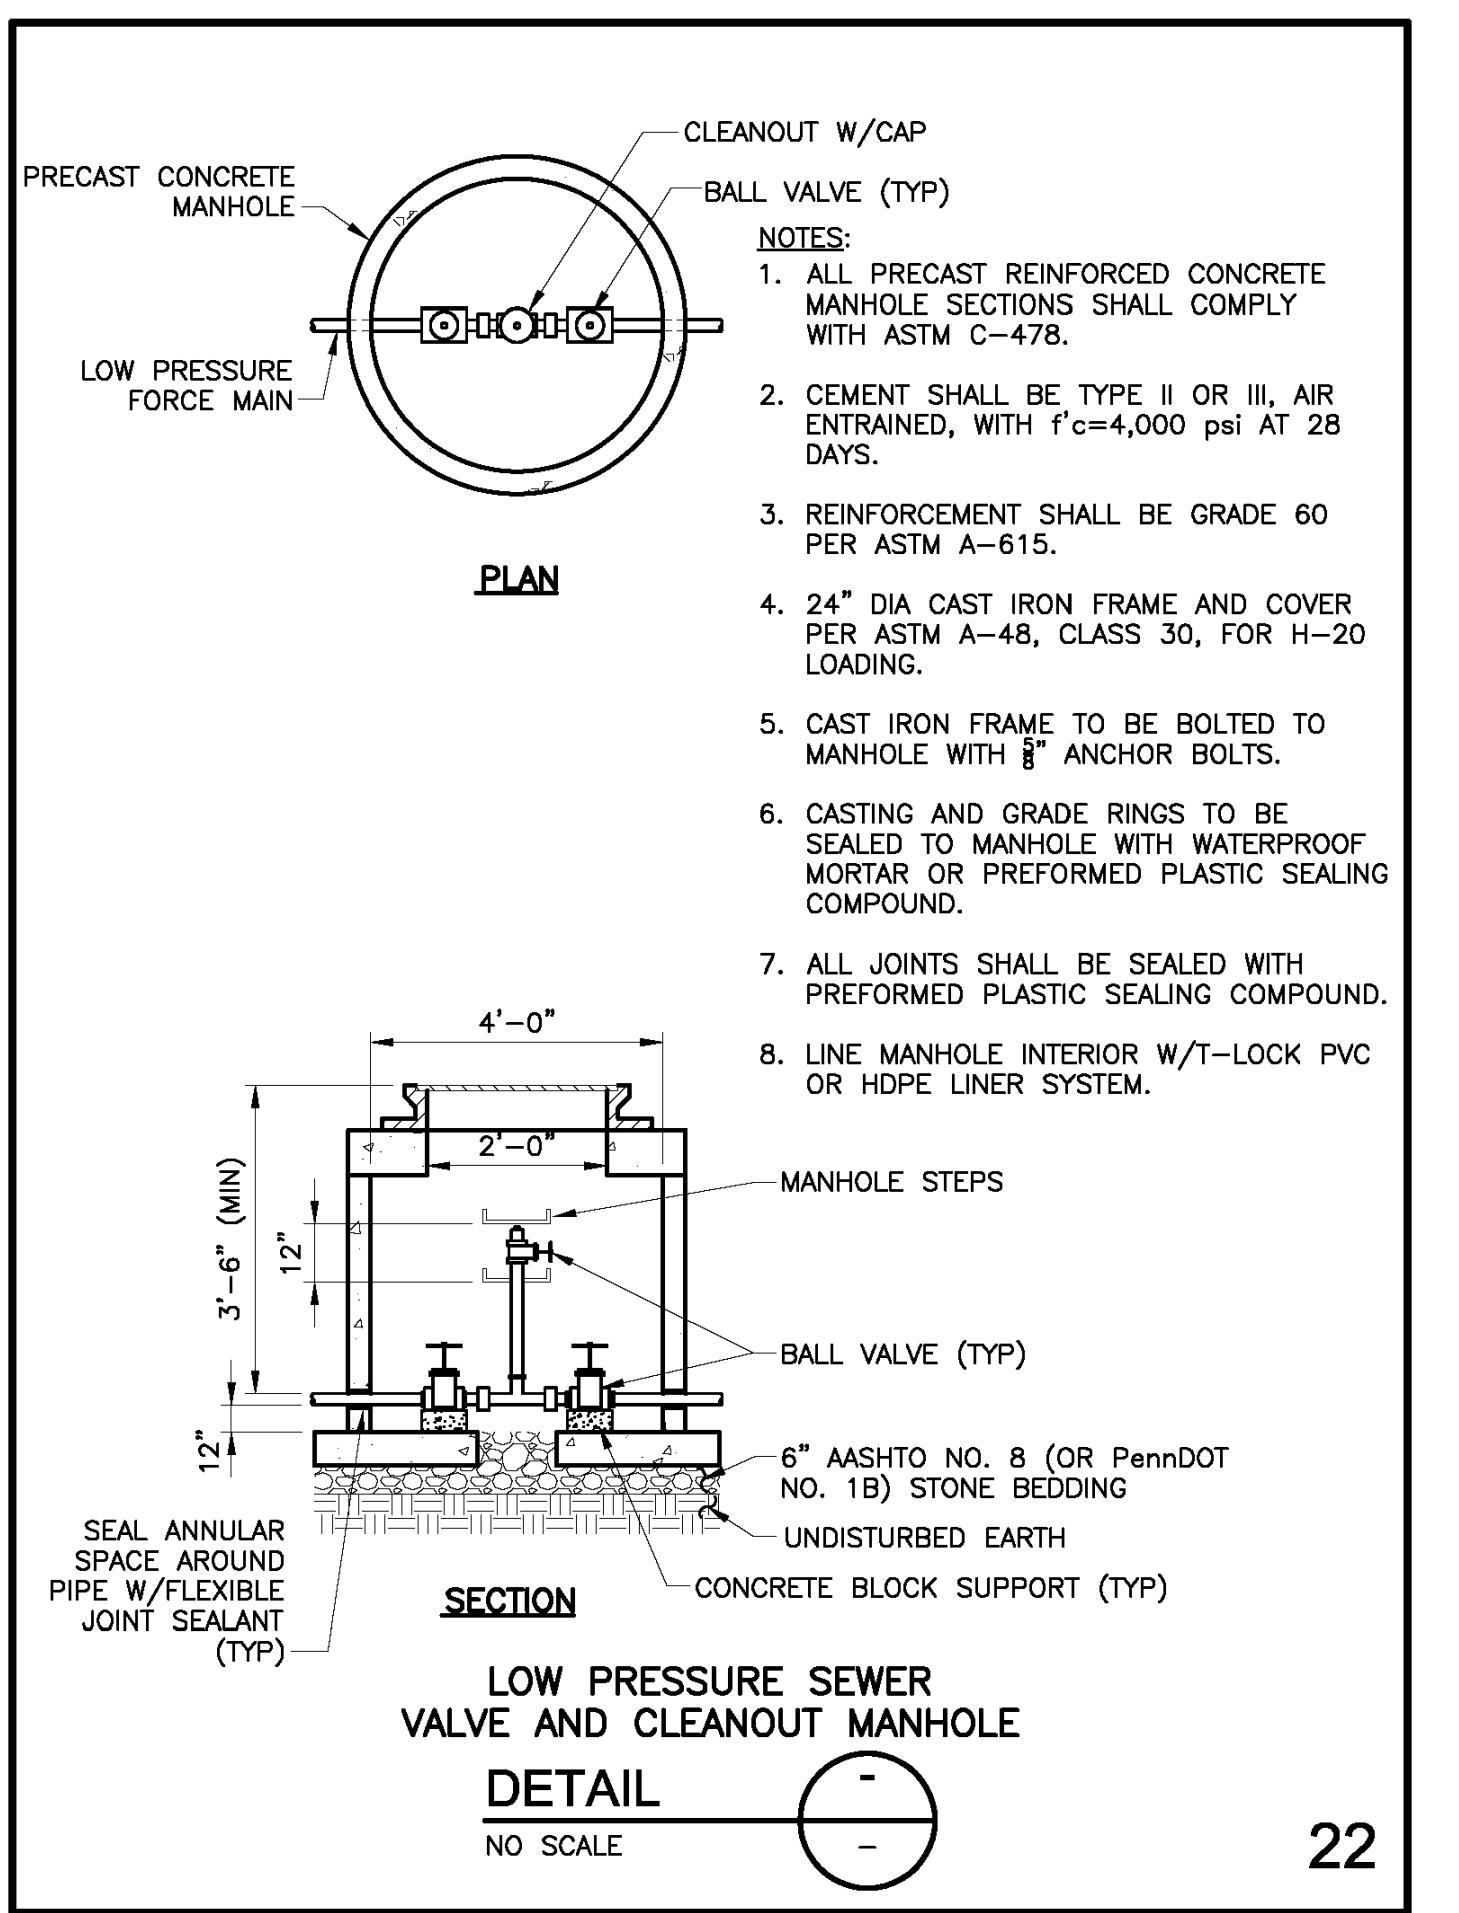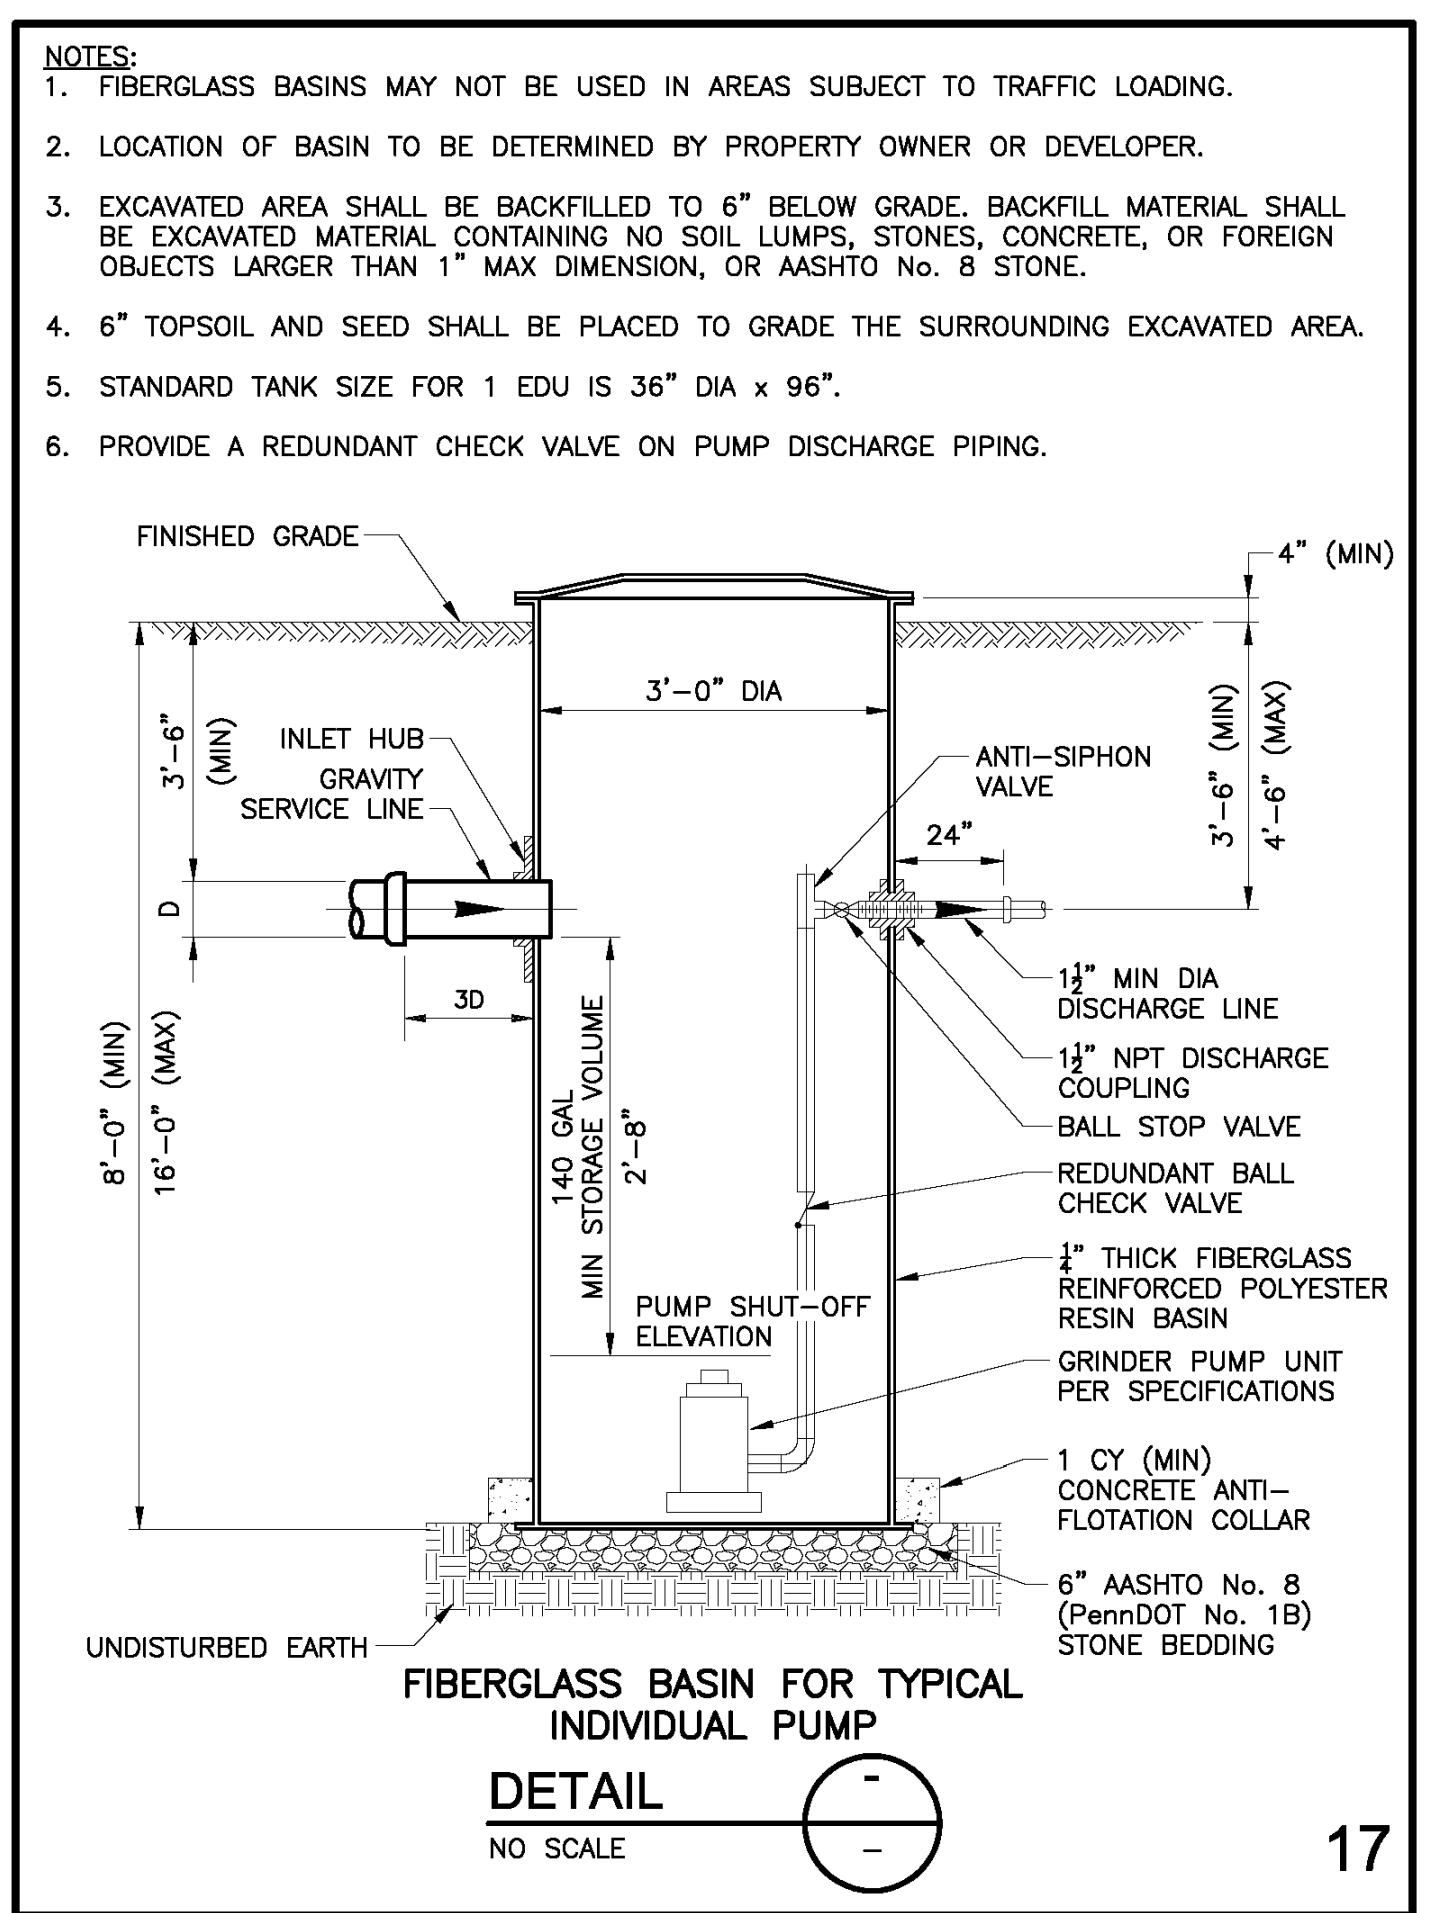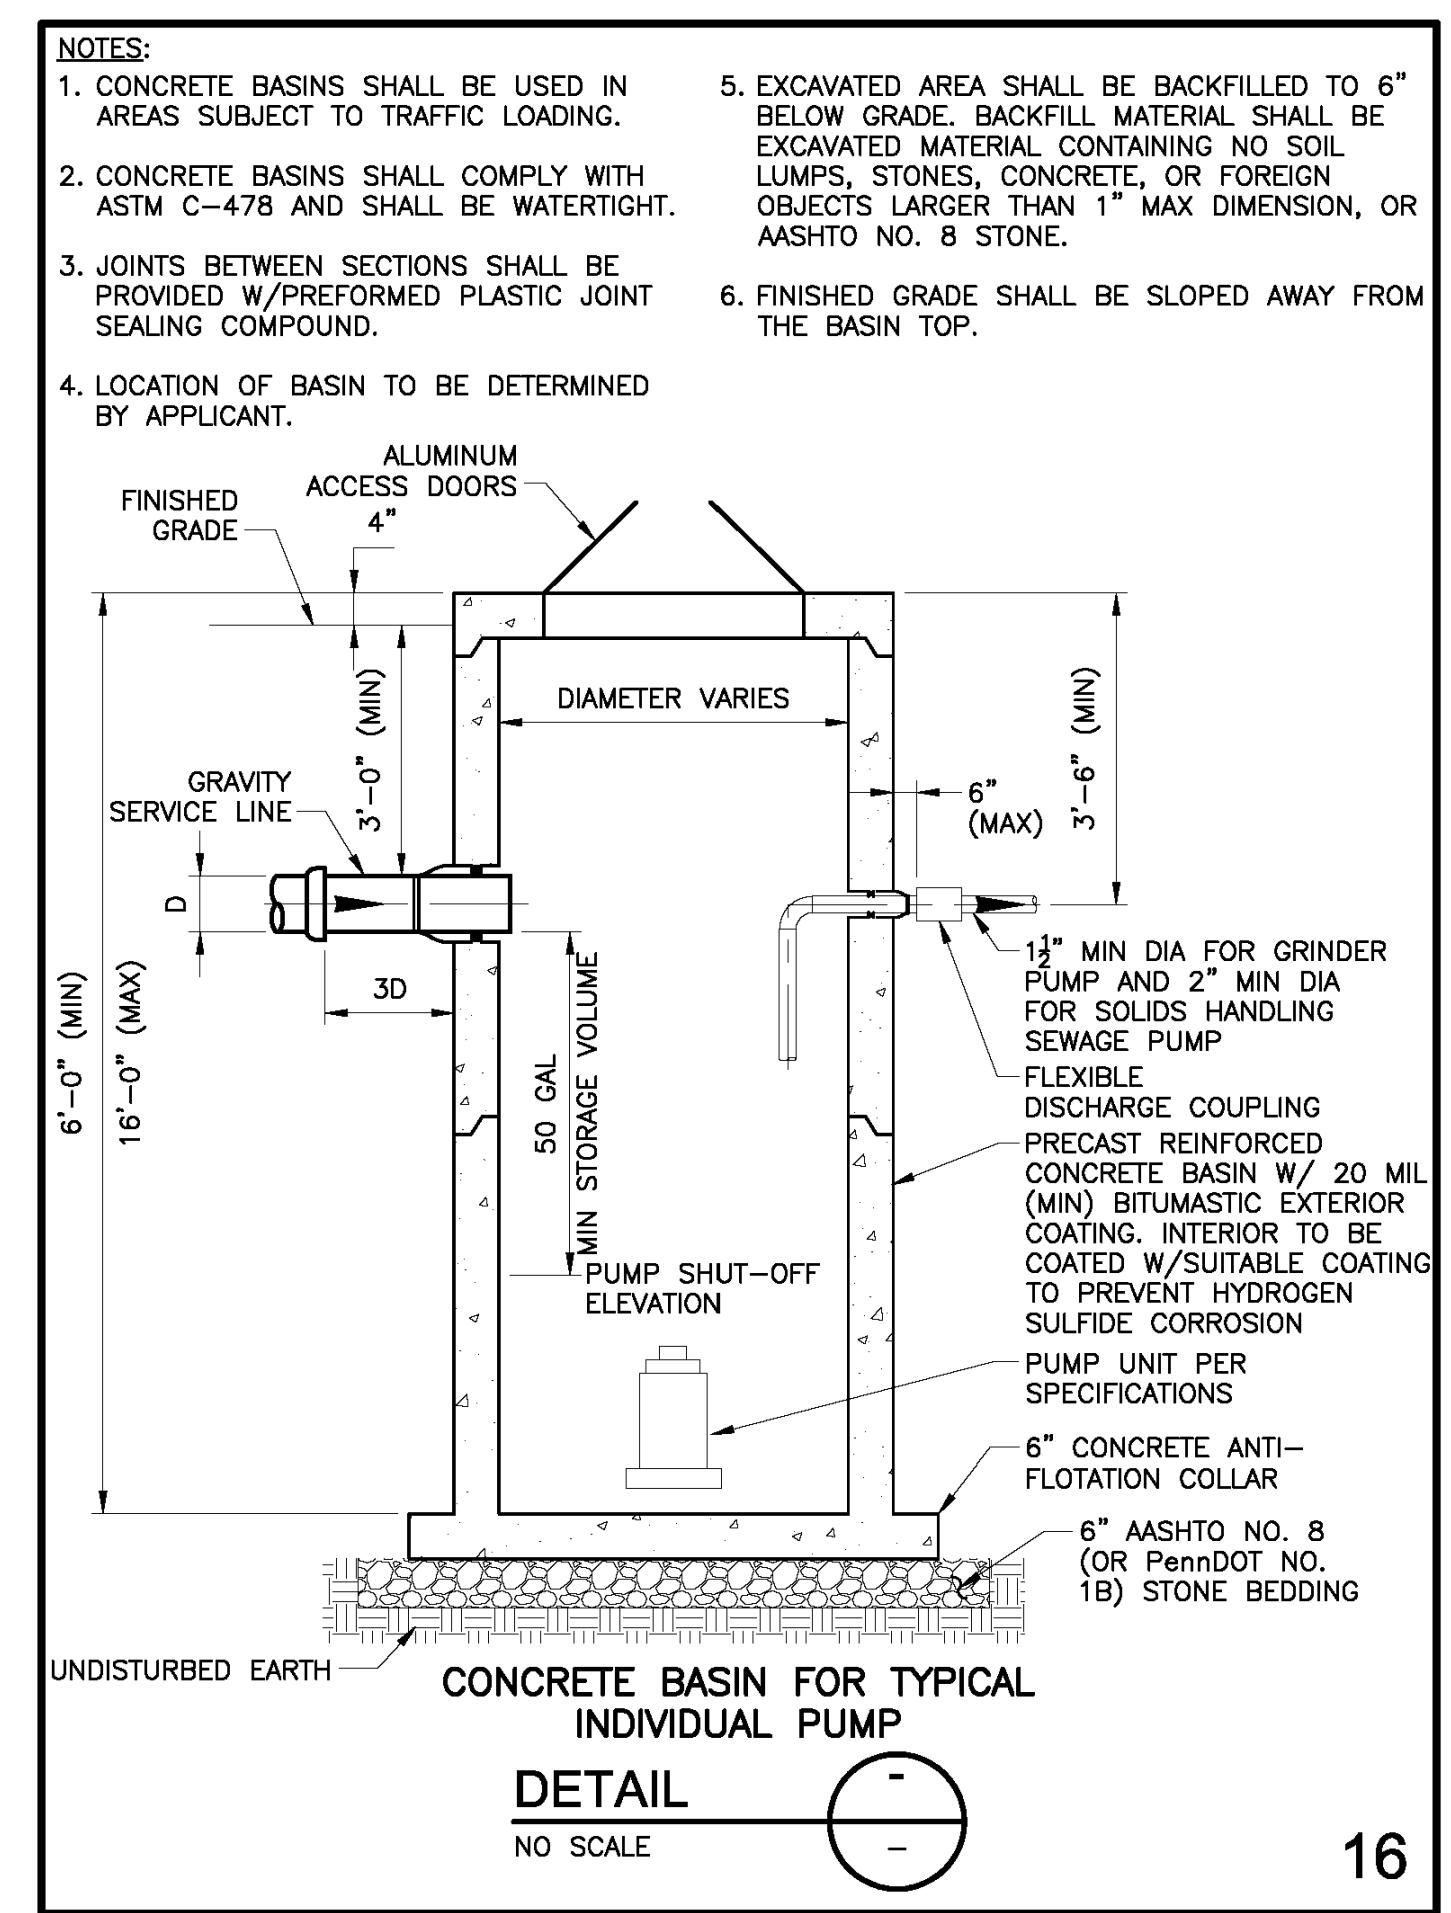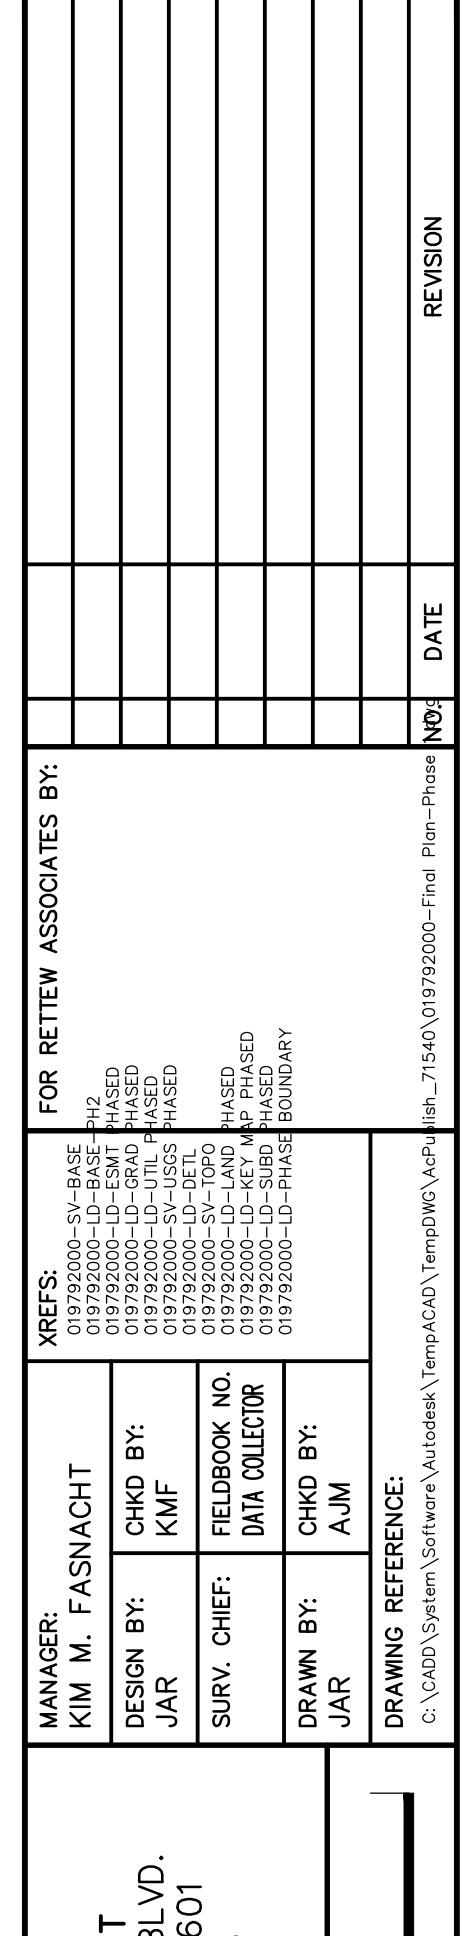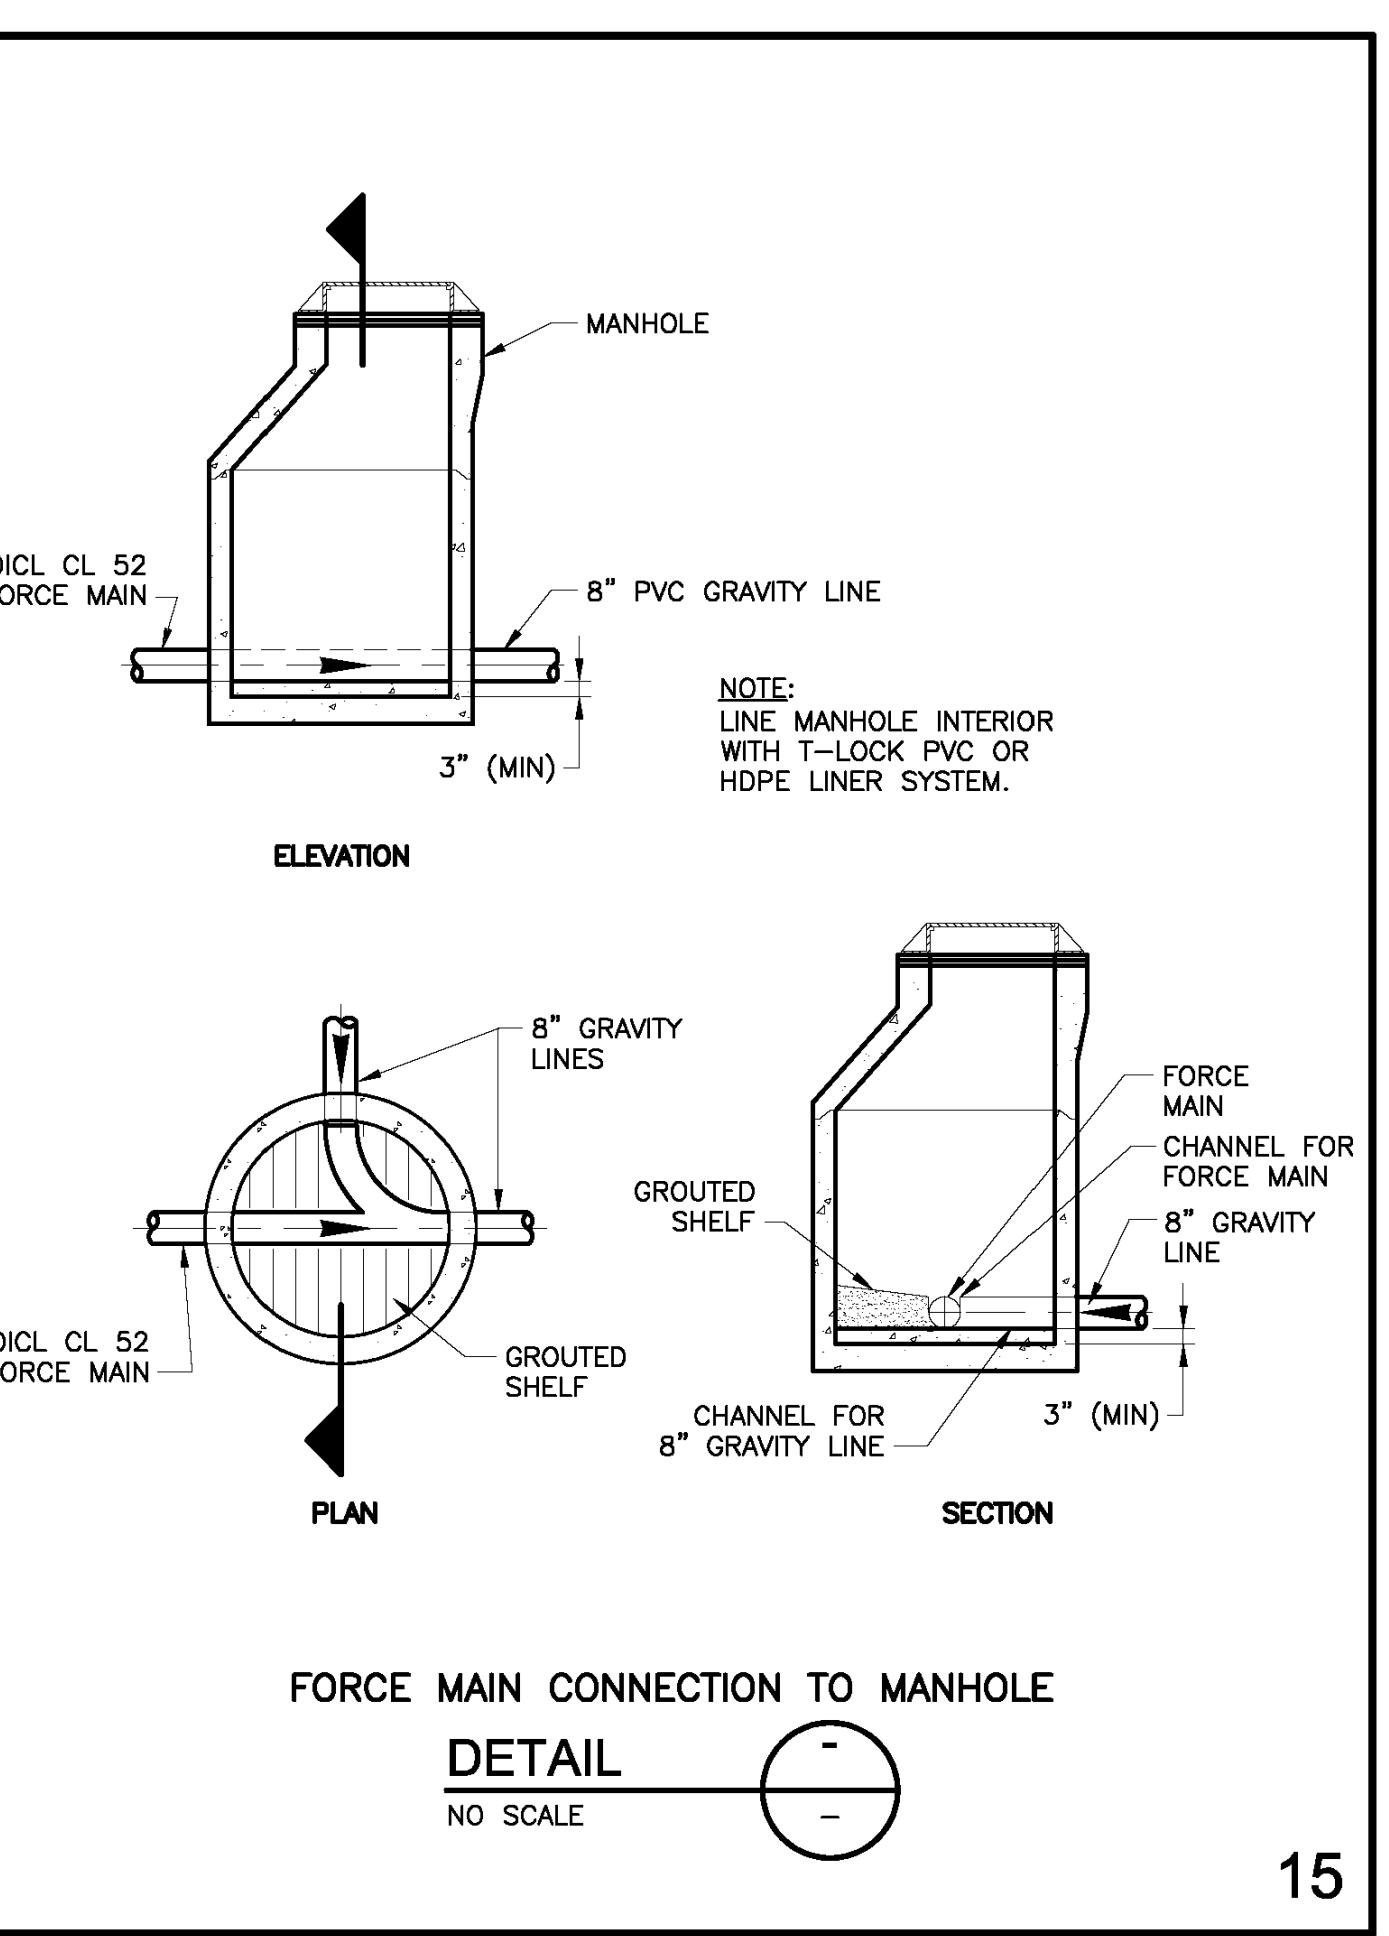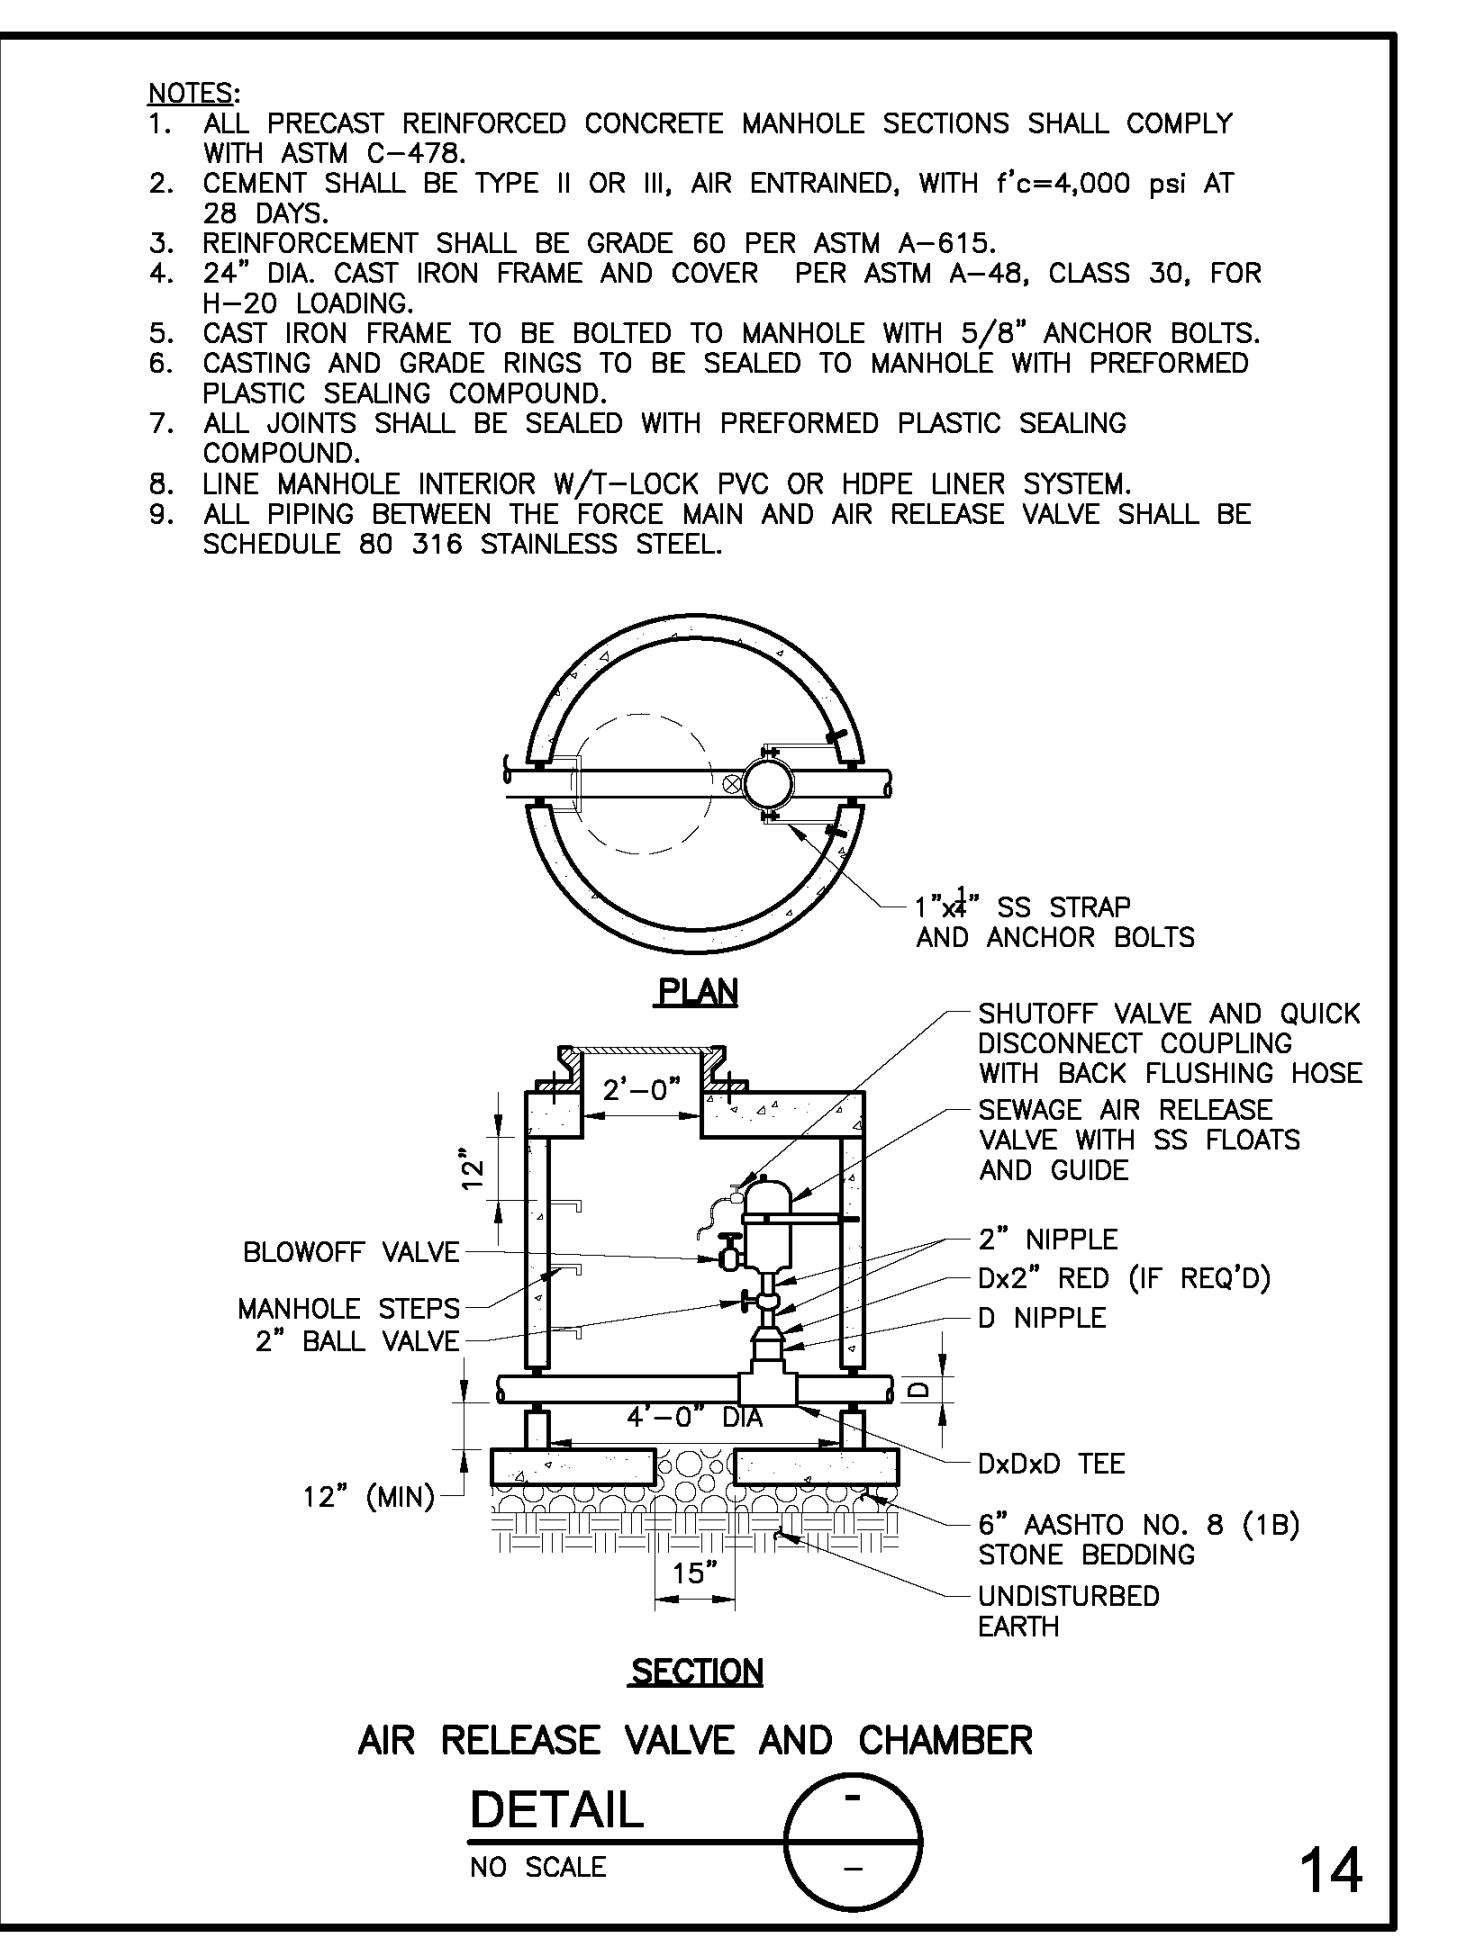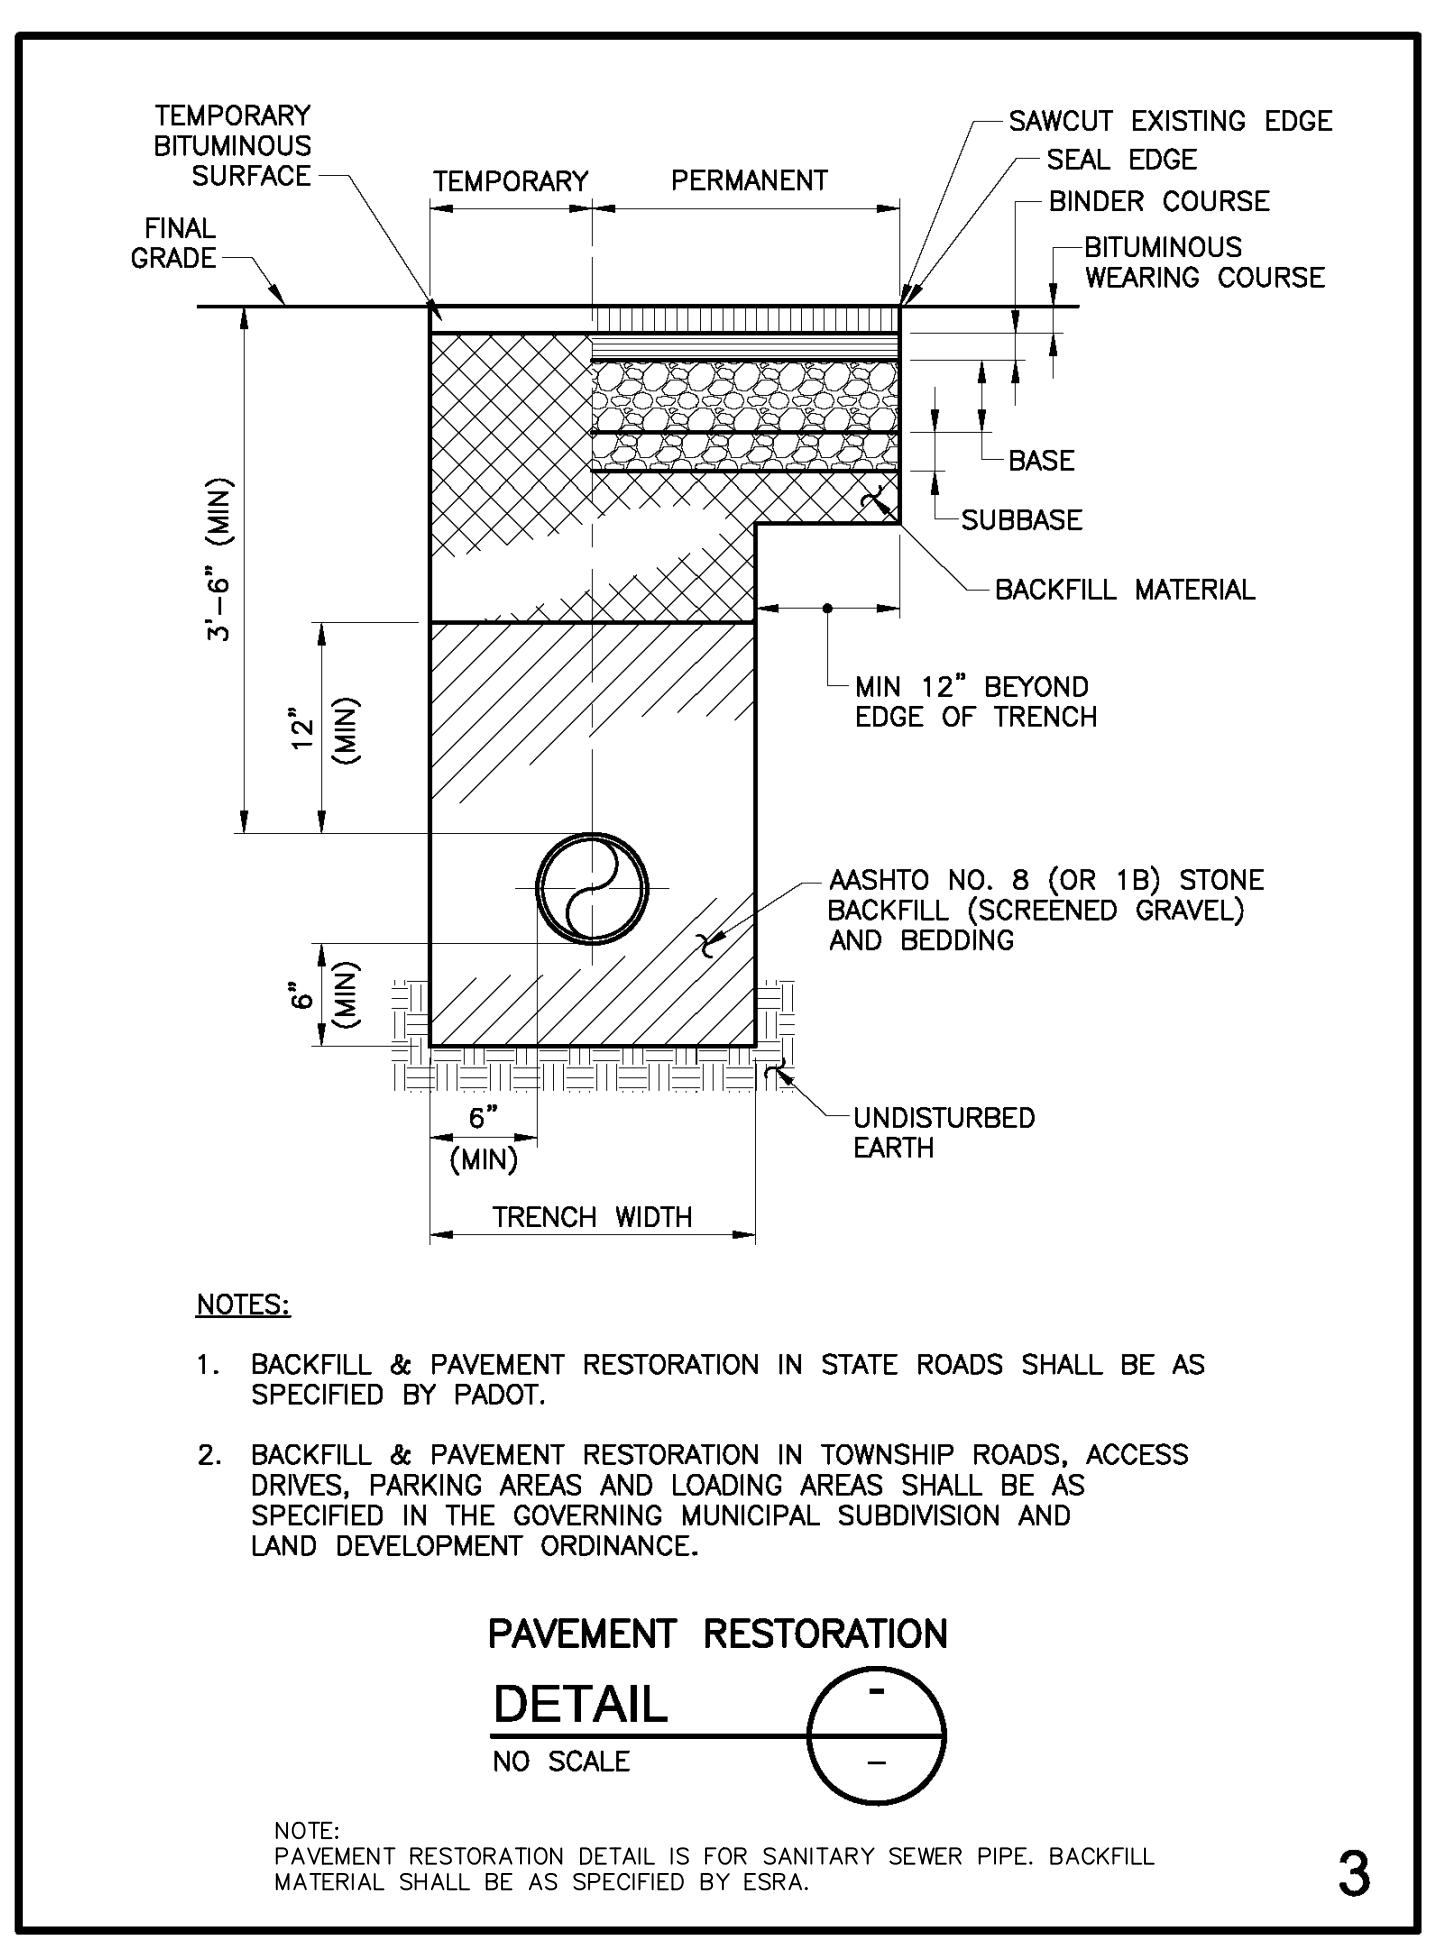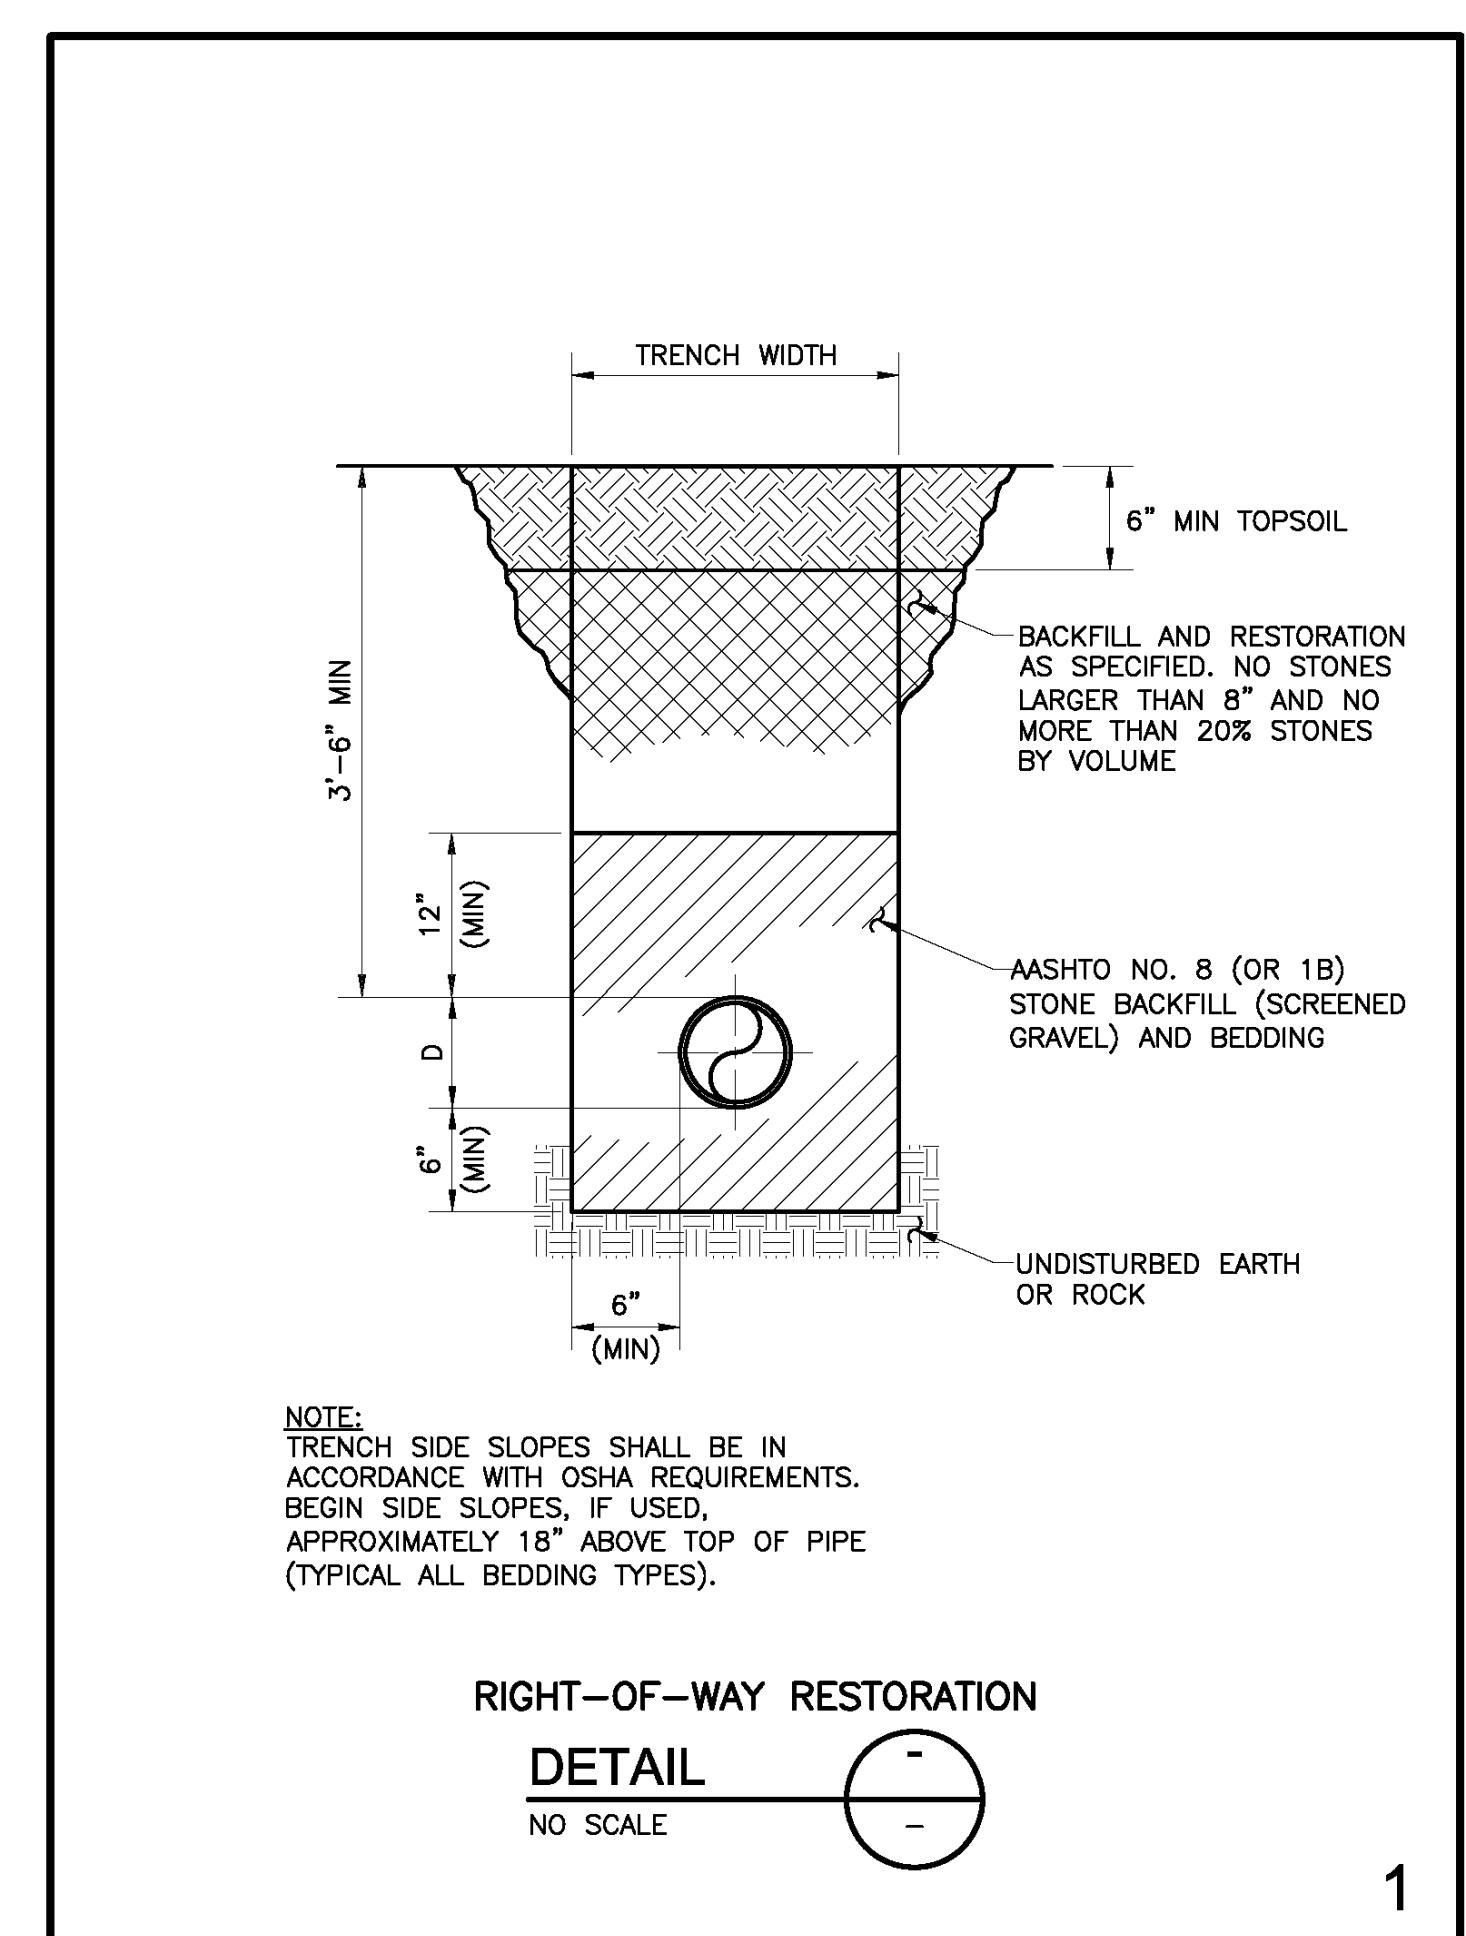

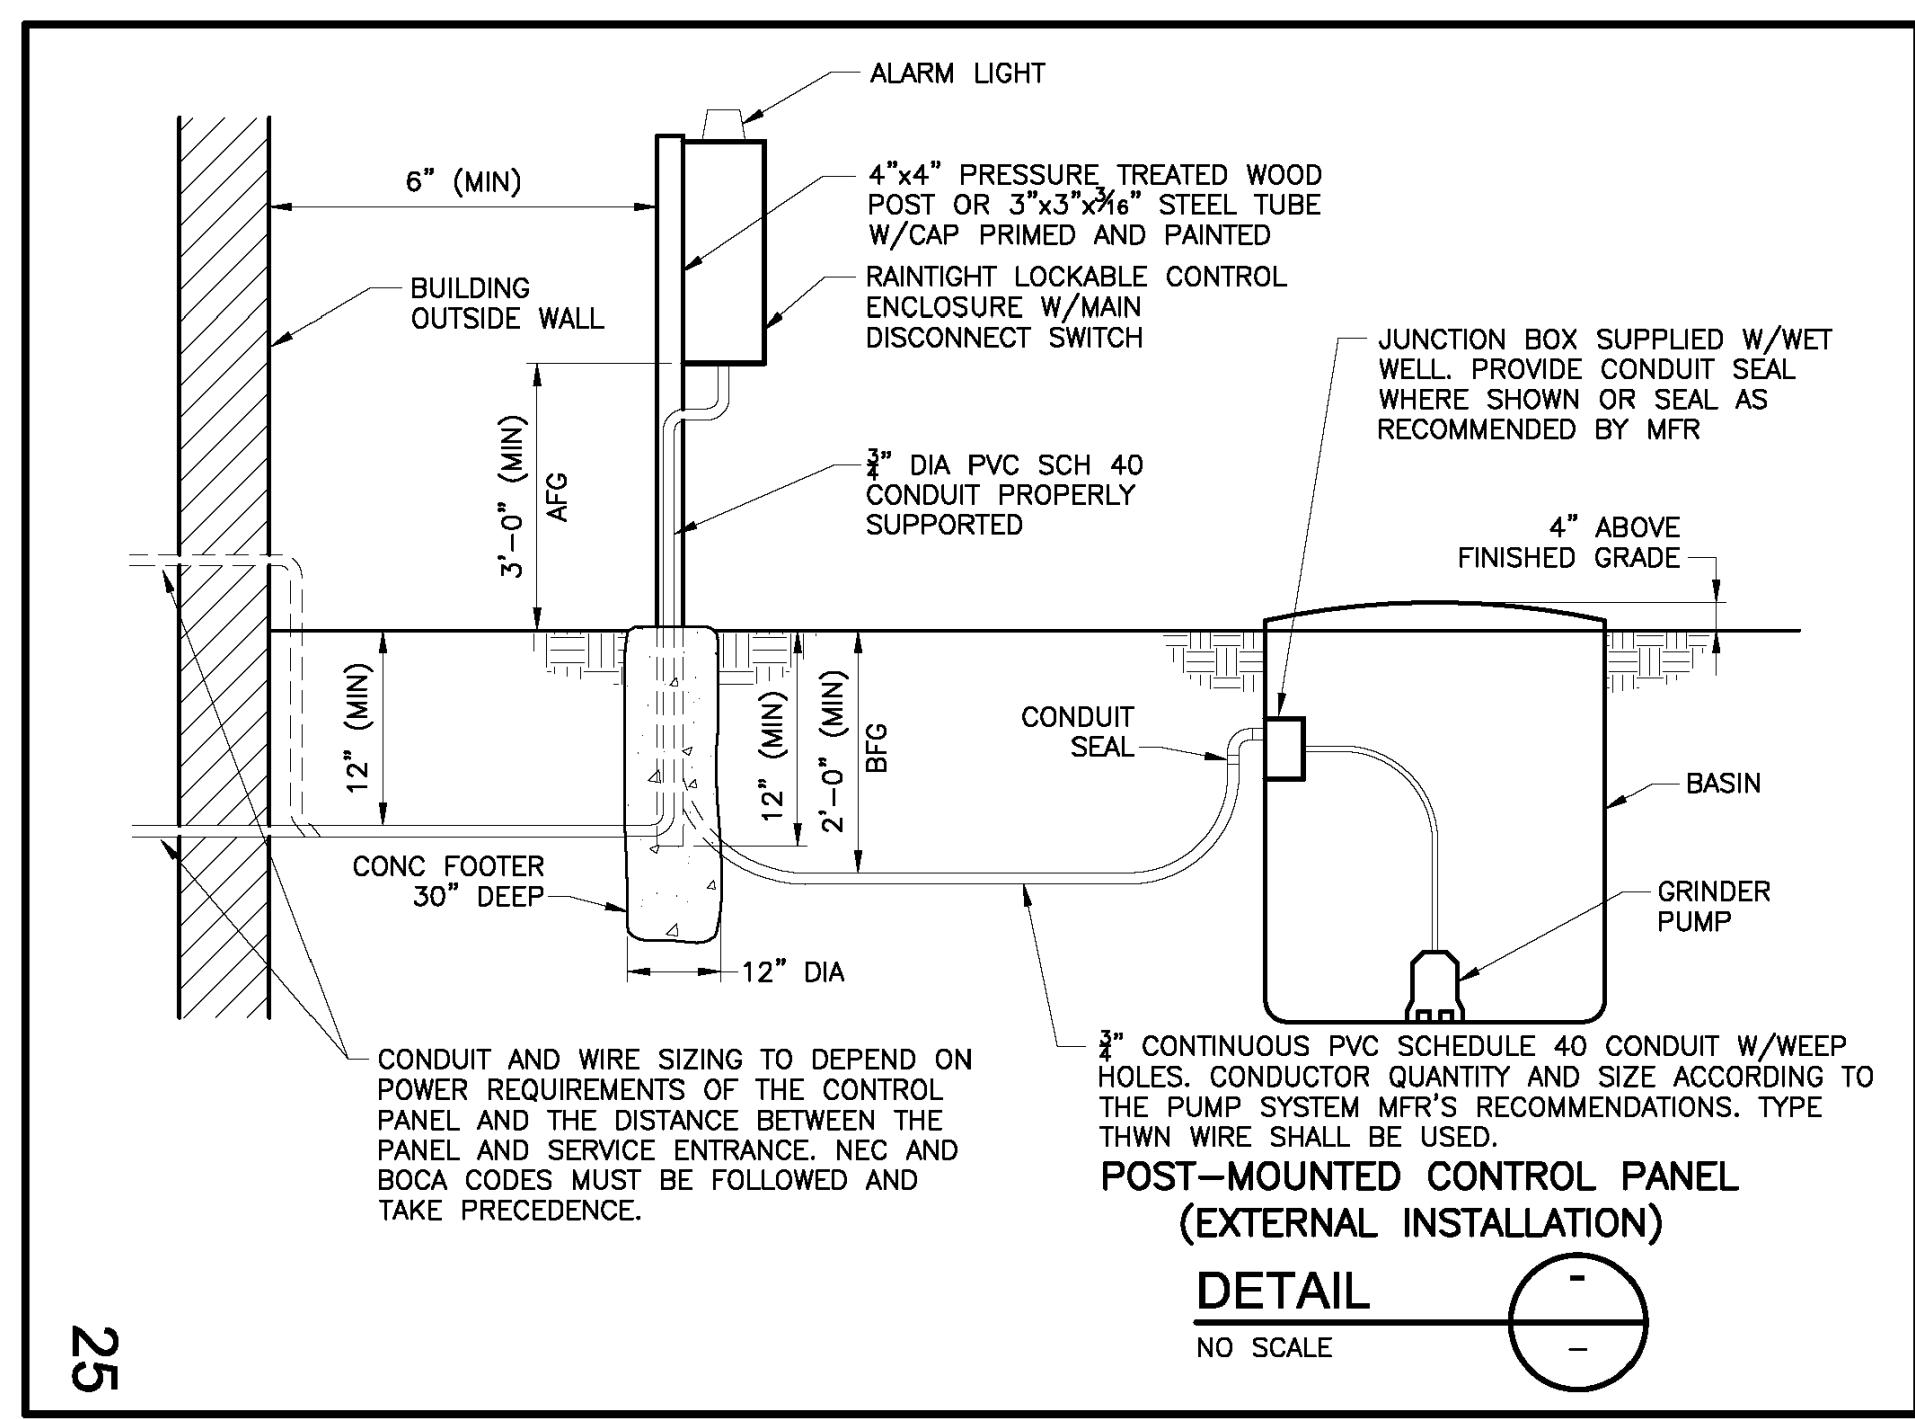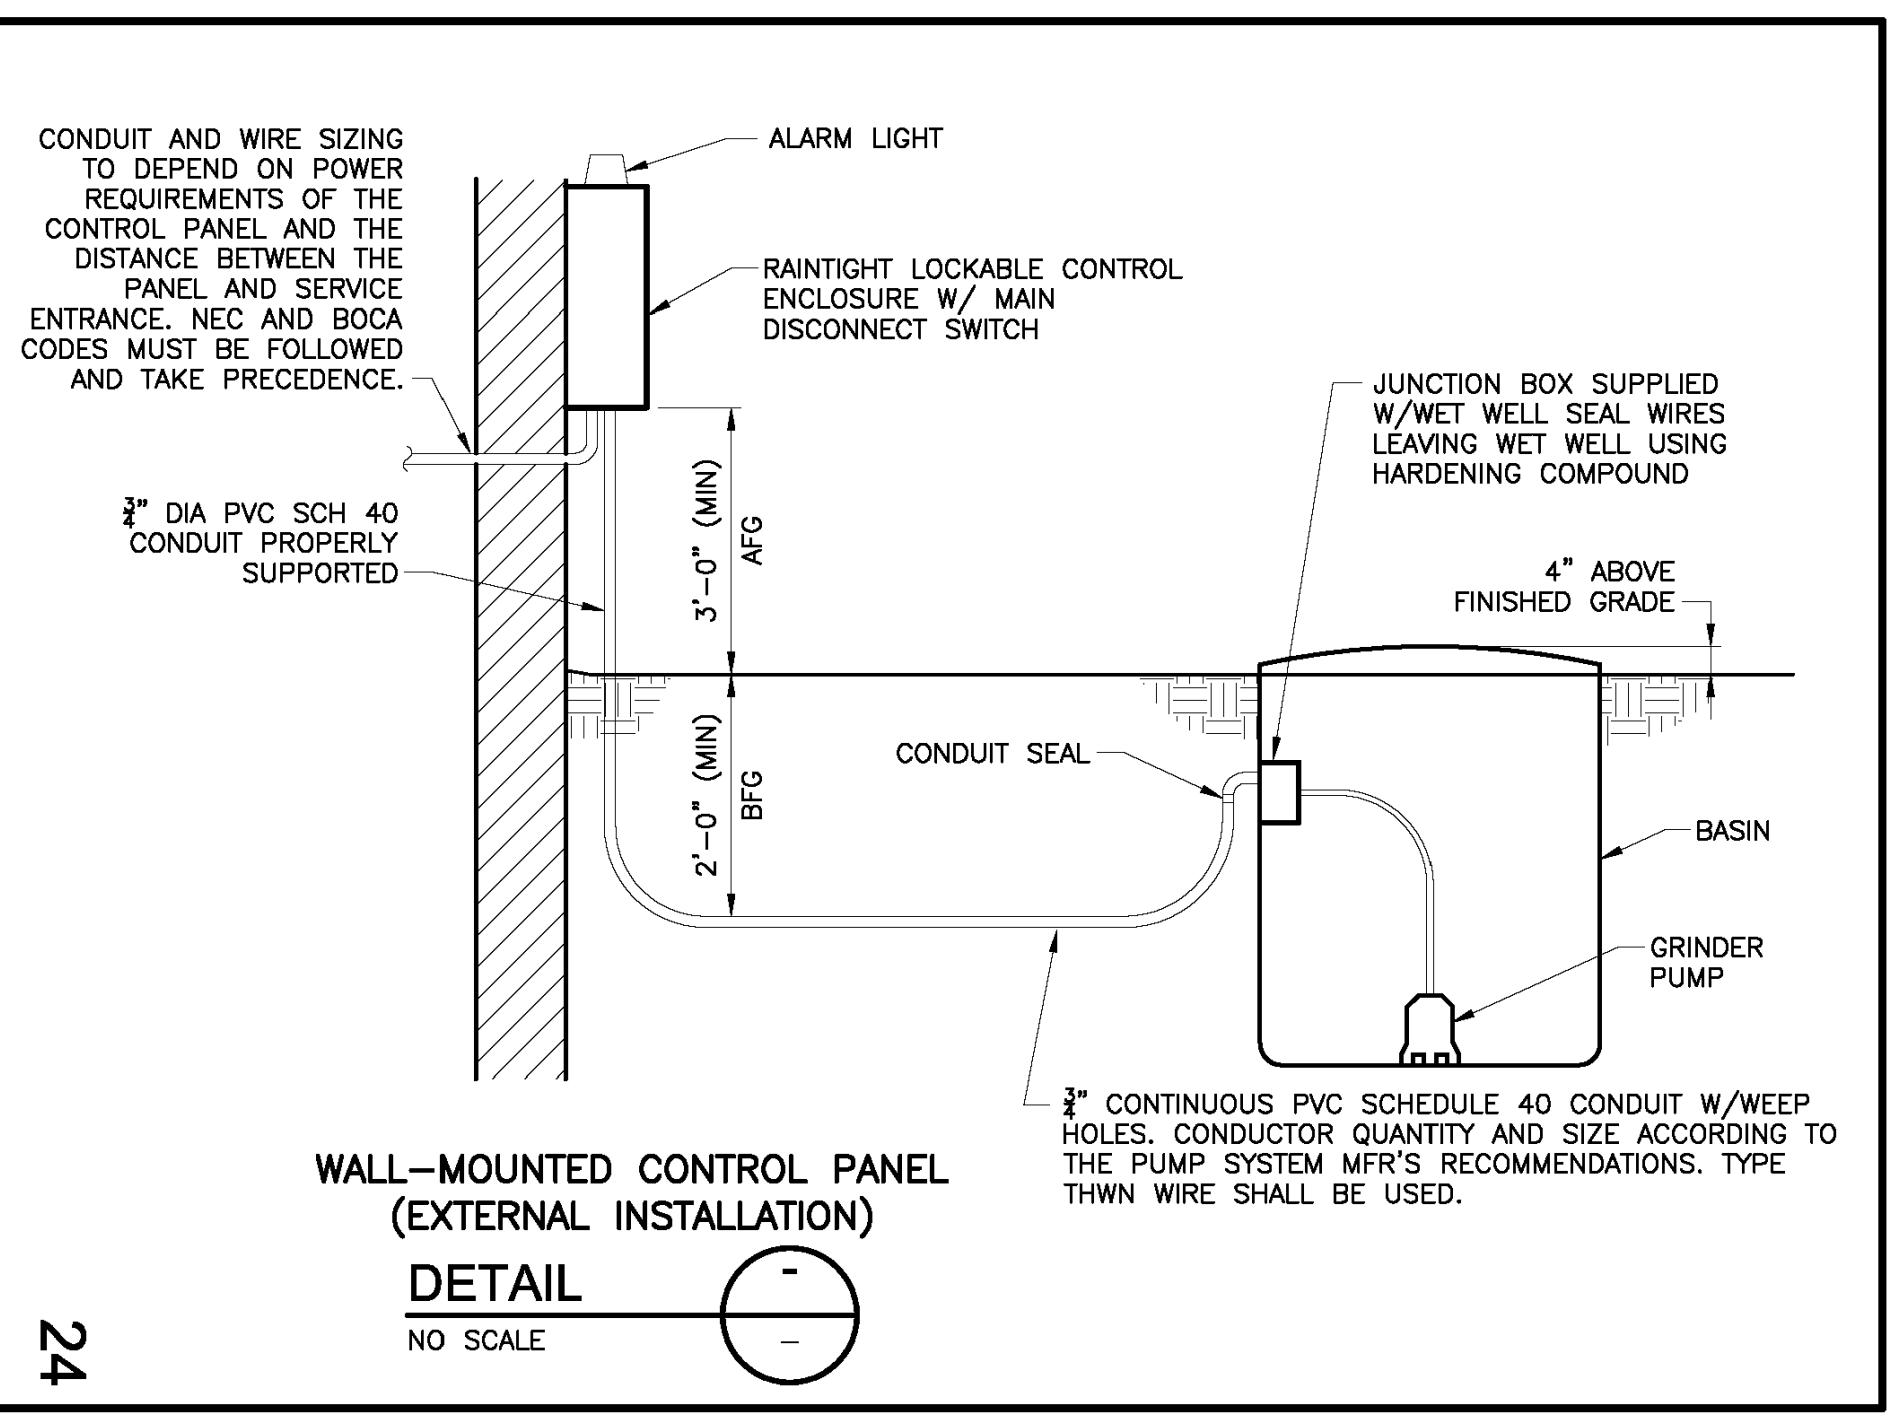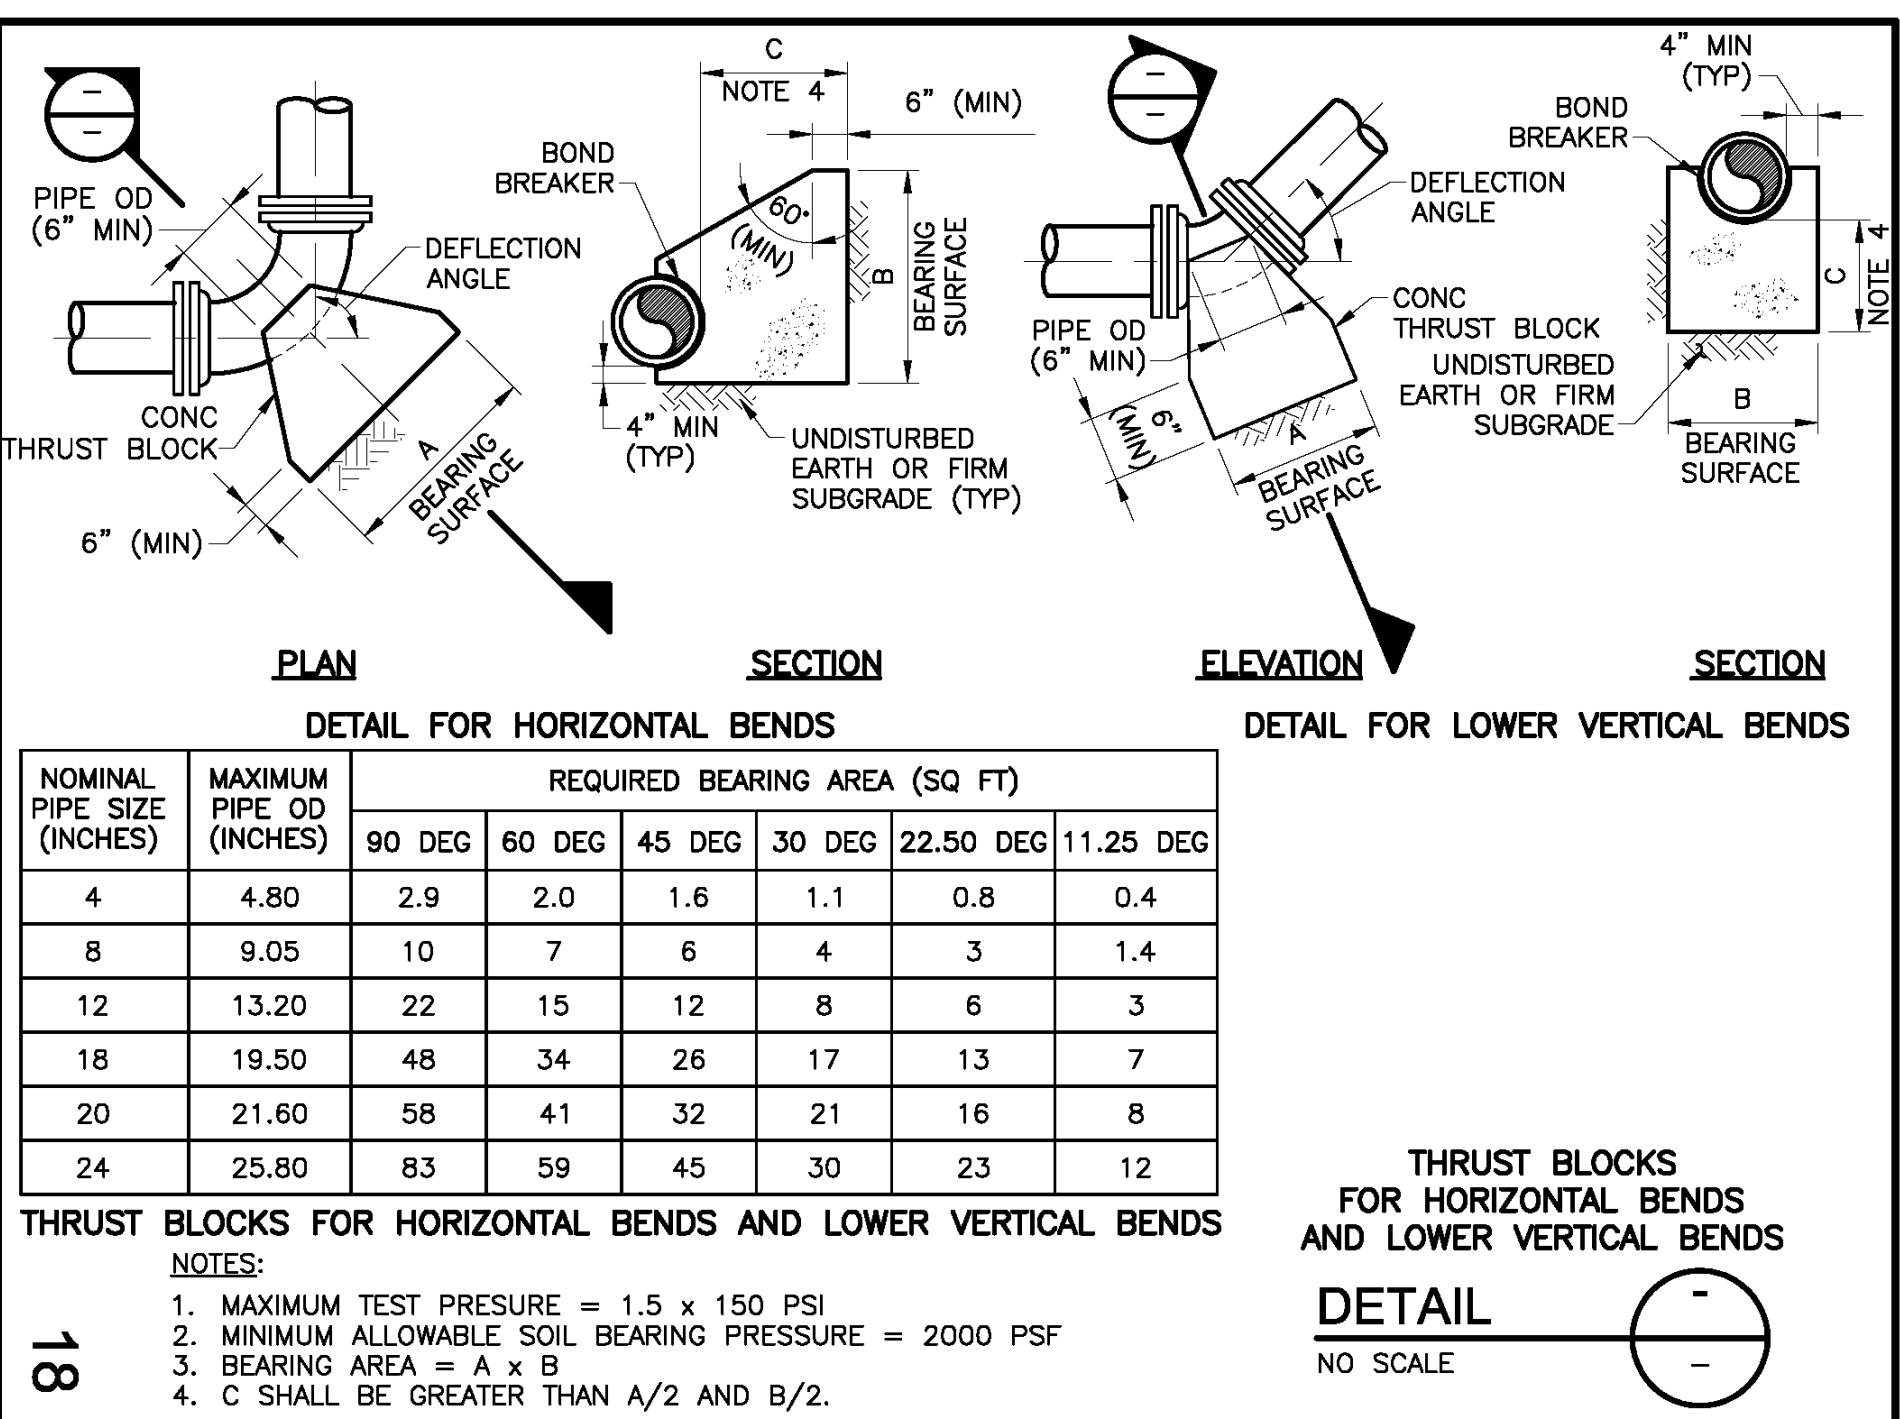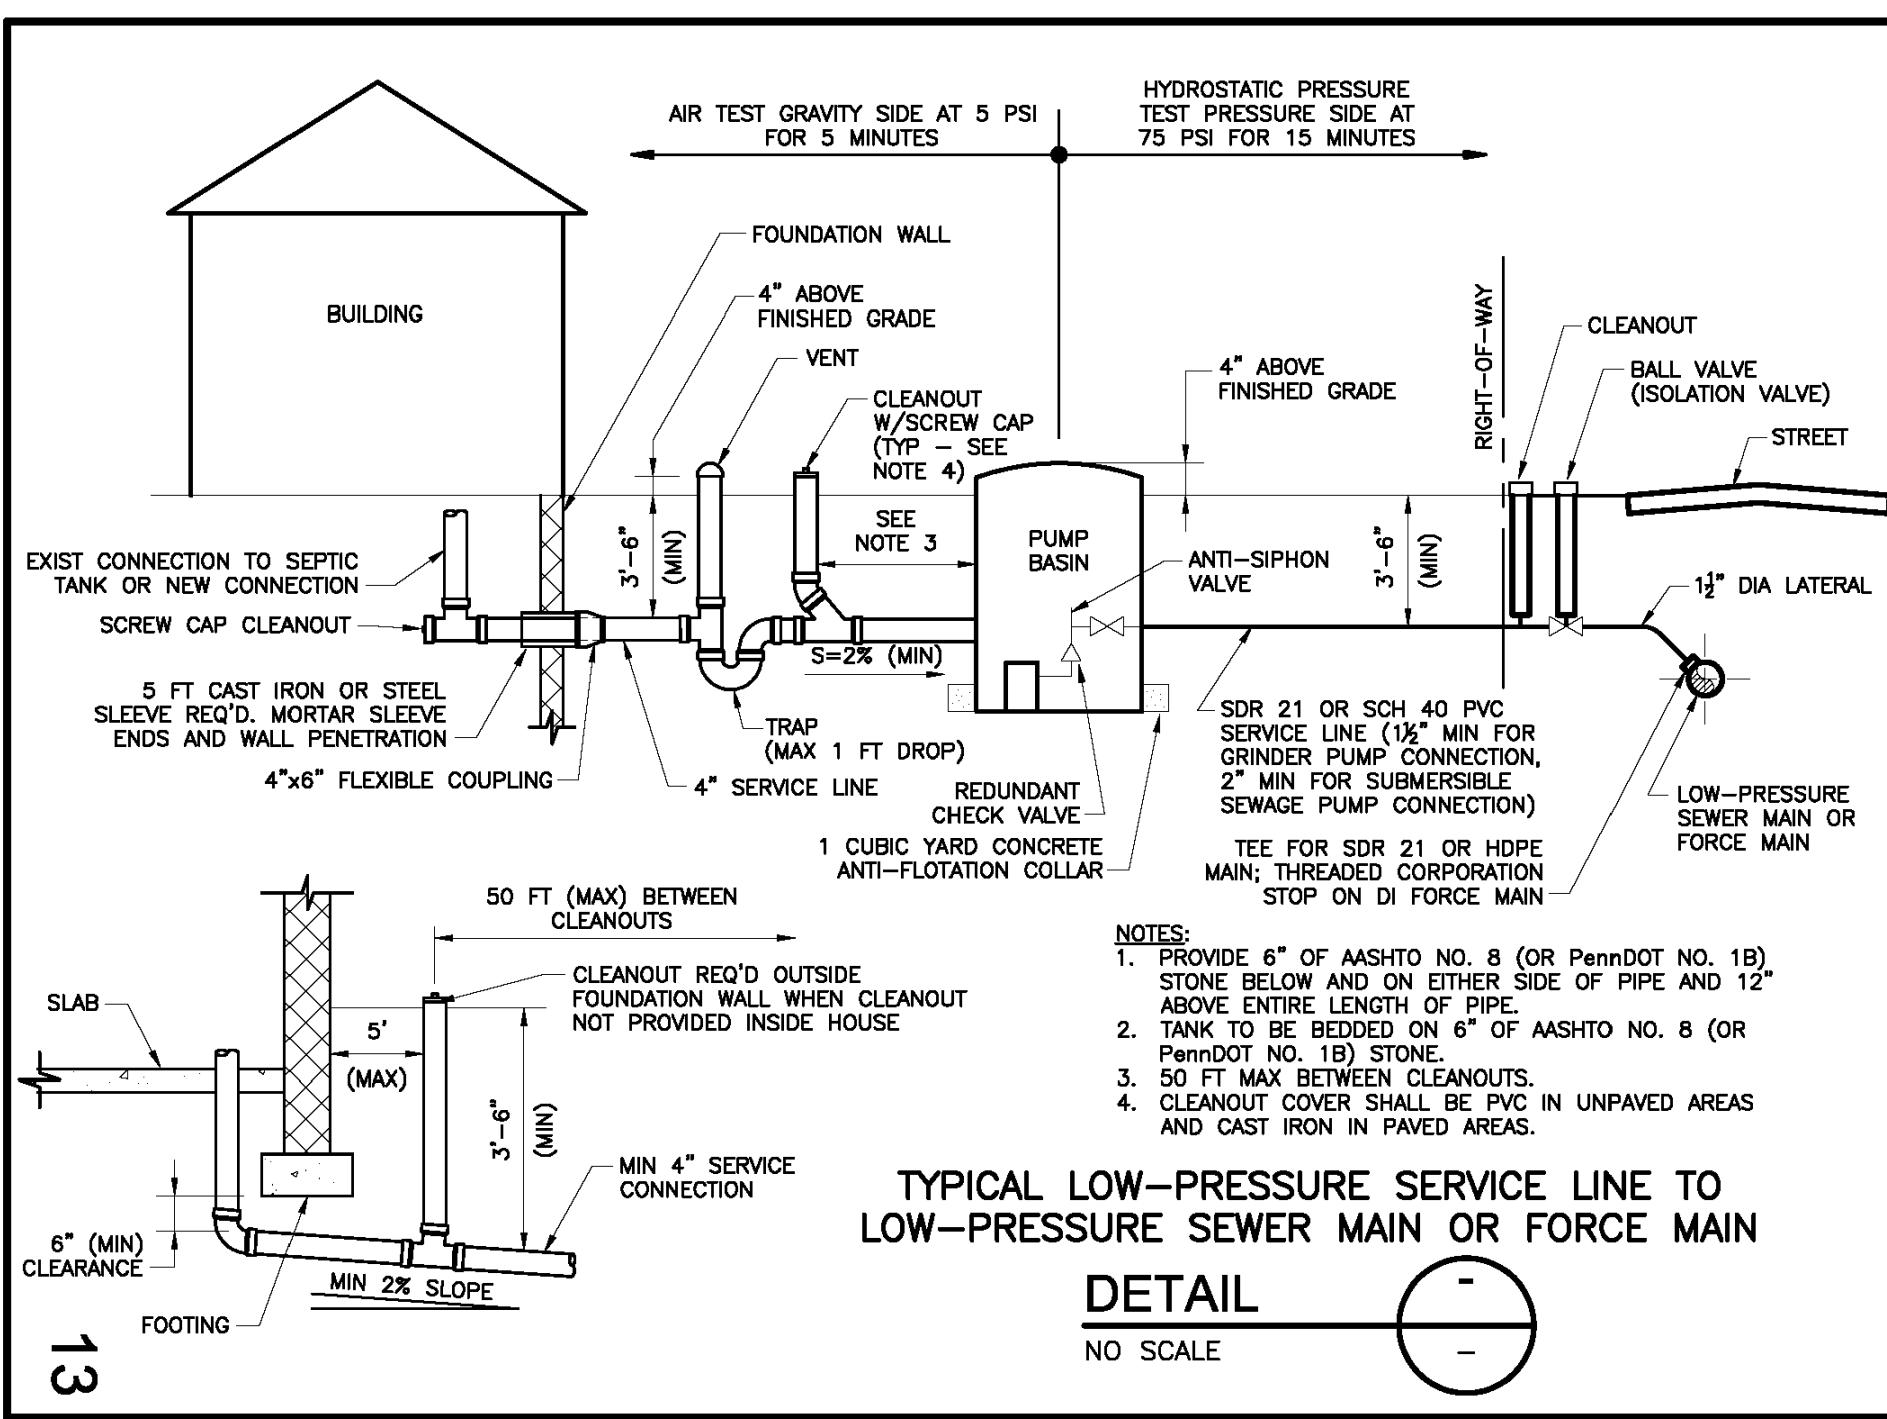

MANAGER: KIM M. FASNACHT	FOR RETTEW ASSOCIATES BY:			
	XREFS:			
DESIGN BY: JAR	CHKD BY: KMF	FIELDBOOK NO. DATA COLLECTOR	019792000-SV-BASE 019792000-LD-BASE-PH2 019792000-LD-ESMT PHASED 019792000-LD-GRAD PHASED 019792000-LD-UTIL PHASED 019792000-SV-USGS PHASED 019792000-LD-DETL 019792000-SV-TOPO 019792000-LD-LAND PHASED 019792000-LD-KEY MAP PHASED 019792000-LD-SUBD PHASED 019792000-LD-PHASED BOUNDARY	
SURV. CHIEF: JAR	CHKD BY: AJM			
DRAWN BY: JAR				
DRAWING REFERENCE:				
C:\CADD\System\Software\Autodesk\TempAcad\TempDWG\AcPublish_71540\Final Plan-Phase			REVISION	
			DATE	
			NO.	

KGH DEVELOPMENT
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CLIENT
NTS

RETTEW Engineering • Surveying • Landscaping

RETTEW Associates, Inc.
3020 Columbia Avenue, Lancaster,
Phone (800) 738-8395
Email: rettew@rettew.com
Website: www.rettew.com

Engineers • Planners • Surveyors • Landscape
Environmental Consultants

DETAILS	FINAL LAND DEVELOPMENT, SUBDIVISION, AND LOT ADD-ON PLAN FOR RAFFENSPERGER - PHASE 1	DATE: 4/12/24	LANCASTER COUNTY, PA
SHEET NO.	32 OF 33	MOUNT JOY TOWNSHIP	
DWG. NO.	019792000		

